

## COMMUNITY DEVELOPMENT DEPARTMENT

## **Planning & Zoning Division**

Caldwell City Hall: 205 S 6<sup>th</sup> Avenue | Mail: PO Box 1179 Caldwell, ID 83606 | Phone: 208-455-3024 https://www.cityofcaldwell.org/Departments/Community-Development/Building-Safety-Division

Robin Collins, PCED, CBO | Community Development Director & Building Official

## **Master Land Use Application**

This Master Land Use Application and specific land use checklists must be completed, with all required supplemental documents provided, prescreening passed, and fees paid for an application to be considered <u>complete</u> and <u>accepted</u>.

Hearing dates and codes utilized for review are based on the date is "complete and accepted".

Failure to submit all requested items (in legible form) may delay the processing of your application.

### APPLICATION LEGEND:

- \* = Public hearing(s) required
- \*\* = May require public hearing
- \*\*\* = City Council consent agenda

All others are considered Administrative Staff Level Reviews

## I. Application Requests (check all that apply)

Admin Director Determination	Lot Split (Administrative)	Subdivision (Prelim) Plat*
Administrative Development Review <sup>2</sup>	Lot Split (Simple)	Subdivision (Final) Plat***
Alternative Method of Compliance	Manufactured Home Community*	Subdivision (Short) Plat*
Annexation w/Zoning*	Mobile Food Unit (Individual)	Subdivision Plat Modification**
Business License (Permit)	Mobile Food Unit Park / Court	Subdivision Plat (Time Extension)
Certificate of Appropriateness*	Modification to Conditions of Approval**	Subdivision Plat (Renewal)
Comprehensive Plan (Map) Amendment*	Outdoor Dining Permit	Temporary Use Permit
Comprehensive Plan (Text) Amendment*	Parcel Consolidation	Traffic Impact Study Review
Deannexation*	Performance Bonding	Vacation (Easement)*
Design Review**	Planned Unit Development (New)*	Vacation (Plat Note) *
Development Agreement (New)*	Planned Unit Development (Modification)**	Vacation (ROW) *
Development Agreement (Modification)**	Public Art / Mural	Variance*
Development Agreement (Termination)*	Rezone* (Zoning Map Amendment)	Zoning Ordinance Text Amendment*
Home Occupation Permit (New)	Signs <sup>1</sup>	
Home Occupation Permit (Renewal)	Special Use Permit (New)*	
Lot Line / Boundary Line Adjustment	Special Use Permit (Modification)**	

### Footnotes:

<sup>&</sup>lt;sup>1</sup>Freestanding, post/pole, or monument signs less than 6' in height. All other signs must be submitted through the building department.

<sup>&</sup>lt;sup>2</sup> Used when not associated with other land use applications, when revisions to an approved (non-subdivision development) is being proposed, or when the land use schedules indicate the requirement for Administrative Development Review.

#### **General Project / Site Information** II.

						_
Project or Development Name: (for business licensing, use business name)						
Site Address(s): Upload separate attached sheet if more than six (6) site addresses						
Suite #s:						
Parcel #s:						
Total Acres:						
Prior Use of Property:						
Proposed Use of Property:						
,						
Current Zoning of Subject Parcel(s): (check all that apply)	☐ RS-1 ☐ RS-2 ☐ -1 ☐ R-2 ☐ R-3	☐ C-1 ☐ C-2 ☐ C-3 ☐ C-4 ☐ H-C	□ M-1 □ M-2 □ I-P	□ D-CC □ C-CB □ T-N	□ A-D □ C-D □ H-D □ P-D	☐ Property in County  List County  Designation:

Proposed Zoning of Subject Parcel(s): (check all that apply)	<ul> <li>□ No Change</li> <li>□ RS-1</li> <li>□ RS-2</li> <li>□ R-1</li> <li>□ R-2</li> <li>□ R-3</li> </ul>	☐ C-1 ☐ C-2 ☐ C-3 ☐ C-4 ☐ H-C	□ M-1 □ M-2 □ I-P		□ D-CC □ C-CB □ T-N	□ A-D □ C-D □ H-D □ P-D
Select the Overlay District for the Subject Parcel(s): (check all that apply)	<ul><li>□ Not in</li><li>○ Verlay Zone</li><li>□ APO-1</li><li>□ APO-2</li></ul>	□ ED-1	□ FP-1	□ HD-1 □ HD-2 □ HD-3	□ SO-1 □ SO-2 □ SO-3	□ UD-1 □ UD-2 □ UD-3
City of Caldwell	□ Neighborho	od 1			)W/D	
Comprehensive Plan Designation of Subject Parcel(s): (check all that apply)	<ul><li>□ Neighborho</li><li>□ Neighborho</li><li>□ Urban Neighborho</li></ul>	od 2 od 3		☐ Mixed U	lse Center unity Center	
Is/Are Subject Parcel Comprehensive Plan		n an "Area H	ub" as indi	cated within	the City of Co	ldwell
□ Yes □ No						
III. Applicant I						
Note: If applicant is an LL	.C, proof of authoriz	ed signer will be	required fron	n the Secretary	of State.	
Name:						
Company Name: (if applicable)						
Mailing Address:						
Phone:		Email:				
Email Address:						
Applicants Relationsh Property Owner:	_	] Property Ov ] Purchaser [		_	ent/Represent quests only)	rative

IV. Property Owners' Info	rmation (if differen	t from applicant)	
			_
Name:			
Mailing Address:			
Maining Address.			
I.			
Phone:	Email:		
Thore.	Lilian.		
V. Contractor / Develope	r Information (f	fill out, if applicable)	
Name			_
Name:			
			_
Company Name:			
(if applicable)			
			_
Mailing Address:			_
Phone:	Email:		
VI. Architect Information	(fill out, if applicable)		
	(m. cas, a spp. cas.c.)		
Name:			
Company Name:			
(if applicable)			
			_
Mailing Address:			
Phone:	Email:		
	23		

## VII. **Civil Engineer / Surveyor Information** (fill out, if applicable) Name: **Company Name:** (if applicable) Mailing Address: Phone: Email: Landscape Architect Information (fill out, if applicable) VIII. Name: **Company Name:** (if applicable) **Mailing Address:** Phone: Email:

## By signing this application, I authorize employees/agents of the City to enter onto the property that is the subject of this application during regular business hours. The sole purpose of entry is to make an examination of the property that is necessary to process this application; and I certify that I am the owner of this property, the owner's authorized agent/representative, or the petitioner (if for a vacation). If acting as an authorized agent or representative, I further certify that I have full power and authority to file this application and to perform, on behalf of the owner, all acts required to enable the jurisdiction to process and review such an application. I will comply with all provisions of the law and ordinance governing this type of application; and I certify that failure to submit all required documents in compliance with the checklist could result in delayed acceptance, processing, and hearing date timelines; and I certify that the information furnished by me as part of this application is true and correct to the best of my knowledge. I certify that I am the: ☐ Property Owner ☐ Authorized Agent / Representative ☐ Petitioner (Vacations Only) Applicant / Applicant's Representative Printed Name Date

IX.

**Applicant Acknowledgement** 

Applicant / Applicant's Representative Signature



October 30, 2025

Morgan Bessaw – Deputy Director City of Caldwell Planning and Zoning Department 205 S 6<sup>th</sup> Ave., 2<sup>nd</sup> Floor Caldwell, ID 83605

RE: Aviary Heights (formerly referred to as Midland 20-26 Lower Five)

Development Agreement, Planned Unit Development, and Preliminary Plat

Dear Ms. Bessaw,

Enclosed for your consideration are applications for *Aviary Heights*, a new planned community, located at the northwest corner of Midland Boulevard and Highway 20-26, as shown below. *Aviary Heights* was previously referred to as Lower Five in the Midland 20-26 approvals in April 2024. *Aviary Heights* includes a Preliminary Plat, Planned Unit Development, and Development Agreement for three hundred five (305) single-family residential lots with associated amenities, eleven (11) commercial lots, and two (2) civic / quasi public lots on approximately 126 acres. *Aviary Heights* will provide a variety of housing to the area, community serving commercial users, a future fire station and a proposed charter school. "Exhibit 1" through "Exhibit 4" are provided as separate documents for ease of viewing.




## **Property History**

### **FUTURE LAND USE MAP**


The Future Land Use Map designations for Aviary Heights show a mixture of Neighborhood 2 (northern section), Neighborhood 3 (center section), and Mixed Use Center (southern section adjacent to Highway 20-26).



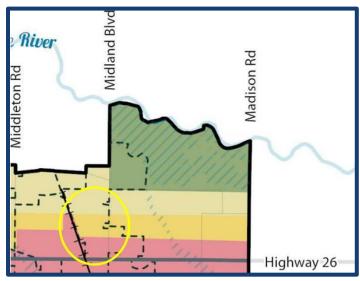

#### **ZONING** Future Land Use Map

Aviary Heights (previously known as Lower Five at Midland 20-26) was rezoned in April 2024 (DA: ZON23-09). That approval established the current zoning (illustrated below) and includes Low Density (R-1), Medium Density (R-2) and Highway Corridor (H-C).

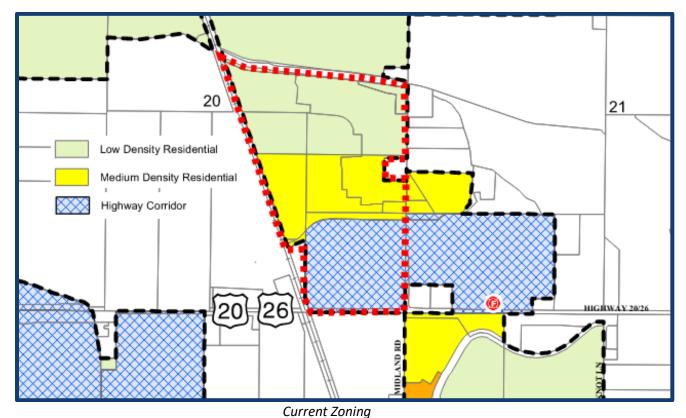

(rezoned as Lower Five at Midland 20-26)

## **APPLICATION IN DETAIL**

**Aviary Heights** is consistent with the previously approved Midland 20-26 application and the Aviary PUD. More specifically, **Aviary Heights** is created for people with a focus on design themes of **Relationships**, **Walkability**, **Lifestyle Choices**, **Vibrancy and Wellness**. These themes are the basis for **Aviary Heights'** thoughtful neighborhood plan with active and passive opportunities throughout.

The design themes are accomplished by:

- Relationships. Connections of people and the land are encouraged
  - Aviary Heights is designed for individuals to interact and have a social experience. Planned spaces for playgrounds, food trucks, dog parks, covered shelters, and parks will bring residents together. Additionally, a Lifestyle Director will quickly connect people in locations that encourage human contact.
- Walkability. Casual interactions with flexible and adaptable spaces
  - Aviary Heights offers an extensive and connected pathway system to active and passive locations. These are intentionally designed for variety and connectivity.
- Lifestyle Choices. Availability of innovative and diverse housing options
  - Aviary Heights has a variety of living opportunities through a mix of lot types, building types, home sizes, and designs throughout the entire community. Aviary will maintain design standards through architectural control.
- Vibrancy. Mix of uses that welcomes both housing and commerce
  - Aviary Heights includes residential, commercial and civic uses that will serve the community and surrounding area, and support small business.
- Wellness. Promotes living a healthy lifestyle
  - Aviary Heights has focused places that promote healthy living, and include pathways, gathering center, swimming pool, and large areas for games / group exercise.

**Aviary Heights'** amenity plan, site concepts, details and renderings are provided in the Preliminary Plat, Planned Unit Development and Development Agreement applications.

### **PRELIMINARY PLAT**

**Aviary Heights** offers a diverse range of housing opportunities and lot sizes, represented below. In the Northern R-1 zone and perimeter R-2 zone (represented in orange), there are 219 traditional homes on lots ranging from 4,325 sf to 14,706 sf. In the Southern R-2 zone (represented in purple and pink), there are 84 paired and 2 detached carriage lane (alley) homes on lots ranging from 1,874 sf to 3,327 sf. The variety of lot sizes and home types makes **Aviary Heights** a well-balanced community, allowing the neighborhood to meet changing housing needs and preserving a cohesive design.



Exhibit 1

As proposed, the overall density of *Aviary Heights* is 2.447 du/acre over approximately 126 acres, including the commercial parcels, school site and fire department site. The residential portion of the project is limited to the R-1 and R-2 zones on approximately 74.199 acres. The table below represents the zoning, land use designation, allowed density range and the proposed density in *Aviary Heights*, less the school and fire department sites.

		Allowed Density			Density
Zone	Land Use	Range	Lots	Acreage	(du/acre)
R-1	Neighborhood 2	2 – 8 du/acre	160	51.450	3.11
R-2	Neighborhood 3	4 – 20 du/acre	145	22.749	6.37
		Total	305	74.199	4.11

In addition, there are eleven (11) commercial lots, one (1) fire department and one (1) school site on approximately 46 acres.

Use	Zone	Land Use	Lots	Acreage
Commercial	H-C	Mixed Use Center	11	37.241
School Site	R-2	Neighborhood 3	1	7.301
Fire Station Site	R-2	Neighborhood 3	1	1.932
		Total	13	46.474

#### PLANNED UNIT DEVELOPMENT

The City of Caldwell's Planned Unit Development process encourages projects that provide a maximum choice of living environments through a variety of housing and building types and promotes a mix of uses that are functionally integrated within the development. The *Aviary Heights* PUD reflects this intent by using the process to enable thoughtful design solutions that would not otherwise be achievable under standard zoning.

Specifically, the PUD allows for a home type not common in Caldwell—carriage lane homes that front directly onto shared open space. This design has been successfully implemented in Brighton's Arbor and Aviary planned unit development (PUD) communities and provides a unique housing option that enhances walkability, fosters neighborhood connection, and creates a patio home environment with open space steps from each front door. The flexibility offered through the PUD supports this innovative approach while maintaining consistency within the City's broader vision for connected, high-quality neighborhoods.

In this way, the PUD process serves as the framework that allows *Aviary Heights* to deliver both housing diversity and community design that aligns with Caldwell's goals for thoughtful growth.

#### **AMENITIES & OPEN SPACE**

Within a PUD, Caldwell requires a variety of amenities and at least 15% open space. Within the 74.199 residential acres of **Aviary Heights**, there is approximately 14.09 acres of qualified open space, or approximately 19%.

These open spaces provide a variety of amenities including (See *Exhibit 2* on following page for detailed breakdown and location of amenities):

- Five-foot (5') wide concrete pathways connecting the residential areas to all non-residential areas, and amenity space corridors.
- Ten-foot (10') wide paved public pathway along the west border of the development, in accordance with the City of Caldwell 2040 Bicycle and Pedestrian Master Plan.
- Private community center; clubhouse.
- Pool.
- Tot lot with playground equipment.
- Bike repair station
- Dog park with two gated entry points.
- Covered Picnic area with grill.
- Wildlife observation garden.
- Micro-pathways to facilitate pedestrian traffic through the development.

### **CONCEPTUAL, SUBJECT TO CHANGE**



**BIRD NESTING** 



**CUSTOM SEATING** 



**COVERED PICNIC & BBQ AREA** 

In addition to amenities designed for *Aviary Heights* residents, the development includes land for a future charter school and fire station (below; location represented in yellow). This commitment goes beyond the project's boundaries, extending the neighborhood's benefits to the wider Caldwell community and supporting the city's long-term growth.




Exhibit 2

### **PROPOSED PUD MODIFICATIONS**

1. <u>FRONTAGE ONTO COMMON DRIVES</u>: PUD Standard: 10-13-03-L-Access: All lots developed for residential purposes shall have frontage along a public roadway.

<u>Proposed Deviation</u>: While the majority of the single-family residential lots front public streets, the proposed layout includes seven (7) common drives (*typical below*) that provide access and "*frontage*" for twenty (20) lots. As previously demonstrated in the Arbor and Aviary neighborhoods, these common driveways are proposed as an efficient solution to the challenging corner areas of the project.

The driveways will be common lots encumbered by ingress/egress and maintenance easements. The common driveways will be owned and maintained by the *Aviary Heights* HOA.

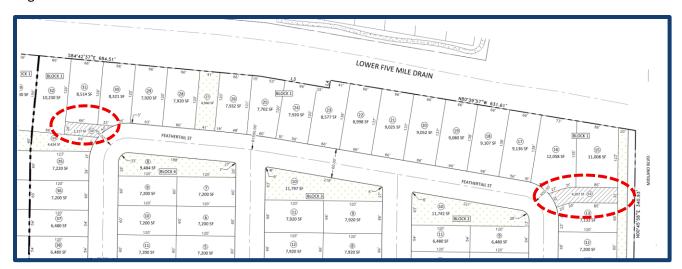

**Common Drive Examples** 

#### 2. FRONTAGE ONTO OPEN SPACE:

<u>Proposed Deviation</u>: **Aviary Heights** includes 51 lots that do not front onto a public street, but instead frontage onto open space. Each of the 51 lots will have vehicular access through a carriage lane (alley), and pedestrian access through the adjacent common open space. A sidewalk, shown in blue, through the common open space provides access to the front door of each home. Each alley provides off-street parking for guests and residents.

Both the alley and common open space will be encumbered by ingress/egress and maintenance easements owned and maintained by the *Aviary Heights* HOA. These homes will all be addressed using the name assigned to each alley.



Frontage Onto Common Open Space

### 3. LOT SIZE / SETBACKS:

<u>Proposed Deviation</u>: As allowed through the PUD process, the proposal includes a request to modify the height, lot line setback, and lot dimension schedules as follows:

### 10-02-03 Table 2 – Height, Lot Line Setback and Lot Dimension Schedule

#### R-1 Standard

							Interior	Corner	
R-1		Front	Front		Interior	Street	Min.	Min.	
Zoning	Max	Yard	Yard	Rear	Side	Side	Lot	Lot	Min. Lot
District	Height	Garage	Living	Yard	Yard	Yard	Area	Area	Frontage
Standard	30	22	15	20	5	15	8,000	9,500	50
Proposed	<u>30</u>	<u>20</u>	<u>10</u>	<u>12</u>	<u>5</u>	<u>10</u>	<u>6,480</u>	<u>9,500</u>	<u>40</u>

### **R-2 Standard**

R-2 Zoning District	Max Height	Front Yard Garage	Front Living Front Alley	Rear Yard Rear Alley	Interior Side Yard	Street Side Yard	Interior Min. Lot Area	Corner Min. Lot Area	Min. Lot Frontage
Standard	40	22	15	15	5	15	4,000	5,000	30
Proposed	<u>40</u>	<u>20</u>	<u>10</u> <u>8</u>	<u>12</u> <u>5</u>	<u>5</u>	<u>10</u>	<u>1,870</u>	<u>3,200</u>	<u>25</u>

### **PHASING PLAN**

The conceptual phasing plan submitted with the application (*Exhibit 3* on the following page) reflects project build out in five (5) phases. Brighton's intent is to follow the phasing plan, but market conditions and lot absorption rates will affect how the project is ultimately developed. Below is the lot count proposed for each phase of the project.

	Phase 1	Phase 2	Phase 3	Phase 4	Phase 5*
Residential Lots	89	75	71	70	0
Common Lots	19	14	10	12	0
Commercial	0	2 (1 School and 1	0	0	11
Lots		Fire Department			

<sup>\*</sup>Note: The timing of Phase 5 will be dependent and could proceed ahead of prior phases.



Exhibit 3

### **ACCESS AND CIRCULATION**

The City's Functional Street Classification Map depicts Soaring Heights Dr and Skygate St as collector roadways, in alignment with the project's east and west points of access, shown in yellow. There is also an emergency access point at the northeast corner of the project, shown in red.

Skygate functions as a collector for the residential area between Midland Blvd and the railroad spur. Soaring Heights provides a future east/west connection from Midland to Middleton across the railroad spur north of Highway 20-26. That re-alignment of the intended Joplin Rd connection was necessary due to a conflict with SunRoc's dead-end railroad spur, with the potential disruption of not only that business, but also significant long delays to traffic flow when spur movement or storage is required.

The Soaring Heights alignment, the subject of numerous discussions with City planning and engineering staff, was affirmed in the Midland 20-26 Transportation plan adopted by the City Council's April 2, 2024 approval of the Midland 20-26 Development applications





#### PEDESTRIAN CONNECTIVITY

Aviary Heights has a network of pathways that provide pedestrians with connections throughout the entire community and create a walkable and connected neighborhood (Exhibit 4). All residential homes have <u>five-foot detached sidewalks</u> and Soaring Heights Drive has an <u>eight-foot detached sidewalk</u>. Detached sidewalks provide for adjacent tree-lined streets that offer a safe and comfortable route for residents to walk to visit neighbors, parks, or community spaces. In addition to these sidewalk connections, there are a series of mid-block, <u>five-foot pathways</u> that link streets together and provide more natural routes through landscaped areas. Finally, there is a <u>ten-foot multi-use pathway</u> along the western boundary that connects residents to open space areas and shared amenities. Together, these elements pedestrian

sidewalks and pathways support the *Aviary Heights'* focus on safety, connection, and a neighborhood design that encourages everyday interaction.



Exhibit 4

### **COMMERCIAL**

**Aviary Heights** has thirteen (13) commercial / nonresidential lots across approximately 46 acres (highlighted in yellow below). These parcels are intended for commercial, retail, and civic uses, such as grocery, general retail, daily services, a future fire station site, and a school site. All proposed uses are consistent with the underlying zoning designations, and no modifications are requested to allow non-permitted uses.



**Commercial Areas** 

### **DEVELOPMENT AGREEMENT**

We are requesting approval of a new Development Agreement for **Aviary Heights** that will remove and replace its inclusion within the existing development agreement spanning the entire Aviary area (DEV23-004), as approved in 2024. The execution of a new agreement will

Aviary Heights Page 14

incorporate the "new" project conditions of approval and development requirements pertaining only to **Aviary Heights**.

## **IN CONCLUSION**

Aviary Heights represents a thoughtful neighborhood plan that supports the City's goals and reflects a shared commitment to intentional growth in Caldwell, and is in harmony with the Lower Five Midland 20-26 approvals. With a mix of housing types, connected open spaces, and community-serving uses, Aviary Heights creates a balanced mixed-use development that benefits both residents and the wider community by incorporating the themes of Relationships, Walkability, Lifestyle Choices, Vibrancy and Wellness throughout the design. Brighton respectfully requests approval of the Aviary Heights Development Agreement, Planned Unit Development, and Preliminary Plat applications.

If you have questions or require additional information, please reach out to me for an expedited response.

Sincerely,

**Brighton Development** 

Eli Benski Project Manager



621 Cleveland Blvd., Caldwell, Idaho, 83605 Phone: (208) 455-3021 | Web: <u>www.cityofcaldwell.org</u>

## SUBDIVISION PRELIMINARY PLAT CHECKLIST

The following items shall be included in any application submittal. Additional information may be required, as indicated in your roundtable (pre-app) meeting or upon official review of the plans. Please check the box for each item listed below to confirm submission of the item listed.

### **SECTION I**

SUBMITTAL DOCUM	IENTS & RELATED PLANS	Applicant	Staff
Master Land Use Application	Copy of completed, signed and dated application	<b>✓</b>	
Application Checklist	Copy of completed, signed and dated checklist		
Property Owner Acknowledgement	If the signatory of the application is not the owner of the property, a notarized statement (property owner acknowledgement) must be signed by the legal owner of record and submitted with the application	<b>~</b>	
Proof of Property Ownership	Recorded Warranty Deed for the subject property showing proof of ownership, or evidence of property interest to subject property	<b>✓</b>	
Legal Description of Property	Attach a legal description of the property including metes and bounds to the centerline of all adjacent rights of ways. All legal descriptions shall be certified by a land surveyor registered to the State of Idaho.	<b>~</b>	
Neighborhood Meeting Information	<ul> <li>The verification shall include: <ul> <li>A copy of the letter mailed by the applicant (Min. 15 days prior to meeting)</li> <li>A copy of the 500' mailing list indicating all notified owners, residents and associations</li> <li>A copy of the sign-up sheet from the meeting, with your signature</li> </ul> </li> <li>Note: Neighborhood meetings must have been held within four (4) months of application submission.</li> </ul>	~	
Photographs	Photographs of existing site conditions	<b>✓</b>	
Project Narrative	Narrative fully describing the application request(s), the purpose of the development, existing site conditions, and what is being proposed.	<b>~</b>	
Concept Building Elevations	Colored concept elevations of all four (4) sides of buildings, indicating building heights, colors, materials, windows, doors, and architectural features.		
Site Plan (Scaled)	Site plan, drawn to scale, showing location of all property lines, existing and proposed buildings, utilities, setbacks, easements, and streets with street names.	<b>✓</b>	
Preliminary Plat	High resolution preliminary plat, to scale. See requirements for plan content in Section II below	<b>~</b>	
Landscape Plan	High resolution landscape plan, to scale. See requirements for landscape plan contents in Section III below	<b>✓</b>	



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## **SECTION II**

PRELIMINARY PLAT	CONTENT	Applicant	Staff
Plans to Scale	All mapped data for the same plat shall be drawn at a scale suitable to ensure the clarity of all lines, bearings and dimensions, said scale typically being one hundred feet to an inch (100' = 1"). Whenever practical, scales shall be adjusted to produce an overall drawing measuring eighteen inches by twenty- four inches (18" x 24"), but not exceeding forty-two inches by sixty inches (42" x 60").	~	
Subdivision Name and Location	<ul> <li>The proposed subdivision name and location shall be provided on the plat and shall meet the following:         <ul> <li>Said name shall be approved by the City Mapping Department and shall not being a duplicate name of any other recorded subdivision within Canyon County or any of the cities in Canyon County;</li> <li>Location of subdivision by section, township and range; reference by dimension and bearing to a combination of two (2) section corners, quarter section corners, or recorded monuments. (Ord. 3374, 12-6-2021)</li> </ul> </li> </ul>	<b>✓</b>	
Contact Information	Name, address and phone number of property owner(s), subdivider, engineer, planner, and surveyor who prepared the plat, and any other professional persons involved in the subdivision.	<b>~</b>	
Scale, North Arrow, and Plan Preparation Date	Scale, north arrow and date of preparation including dates of any subsequent revisions.	<b>✓</b>	
Vicinity Map (Scaled)	Vicinity map drawn to a maximum scale of one inch equals five hundred feet (1" = 500'), clearly showing the proposed subdivision or planned unit development configuration in relationship to, as well as, identifying and showing lot lines and street connections of all adjacent subdivisions, all arterial streets, all collector streets and bodies of water.	~	
Topography	Topography based on NAVD 88 datum shown on the same map as the proposed subdivision layout. Contour lines shown at five foot (5') intervals where land slope is greater than ten percent (10%) and at two foot (2') intervals where land slope is ten percent (10%) or less, referenced to an established bench mark, including location and elevation.	<b>~</b>	
Existing Water	Location of existing water wells and type, streams, canals, irrigation laterals, drainage facilities, private ditches, washes, lakes and other water features; direction of flow; regulatory floodplain and floodway boundaries if any; and location and extent of known areas subject to inundation if any.	~	
Streets and other Important Features	Location, widths and names of all existing streets and location, arrows indicating direction of slopes, type of surface and existence of any curb, gutter and/or sidewalks. Other important features such as railroads, utility rights of way and easements of public record, public areas, permanent structures to remain including water wells, and municipal corporation lines within or adjacent to the tract.	~	
Recorded Subdivisions with Common Boundaries	Name, book, page number and lot line layout of any recorded adjacent subdivision having common boundary with the tract.	<b>~</b>	
Table Schedule (see attached example)	Table Schedule of:  Existing zoning classification of the tract with any requested zoning changes.  Total acreage of the entire subdivision  Total number of buildable lots by land use type.  Total number of common lots.  Total gross acreage  Average buildable lot size  Dwelling units per gross acre.	~	



PRELIMINARY PLAT	CONTENT cont.	Applicant	Staff
Subdivision Boundary	The subdivision boundary with dimensions and bearings shall be based on an actual recorded field survey, performed within six (6) months of the preliminary plat application, and shall include the professional land surveyor stamp. Boundary problems shall be resolved prior to preliminary plat submittal. Stamping of the preliminary plat by the professional land surveyor pertains only to the boundary survey and should be noted as such.	<b>✓</b>	
Public dedications of rights of way or easements	Proposed location, width, dimensions and bearings, and use of all proposed easements within the subdivision. All existing easements with location, width, dimensions, bearings, use and instrument numbers. Designation of all land to be dedicated or reserved for public use with purpose indicated.	<b>✓</b>	
Names, Addresses, and Tax Parcel Numbers	Names, addresses and tax parcel numbers for all property owners within three hundred feet (300') of the exterior boundary of the subdivision, displayed visually on the plat in the appropriate locations.	<b>✓</b>	
Utilities	Storm drains and water supply mains, both proposed and existing, within and immediately adjacent to the subdivision. Approximate location of existing sanitary sewer facilities, manholes, lines, and any other sewer related facilities within and adjacent to the subdivision.	<b>✓</b>	
Proposed Street Layout	Proposed street layout, including location, width and proposed names of streets, common driveways, alleys, major pathways, micro pathways and easements; pedestrian and vehicular connections to adjoining properties.	<b>✓</b>	
Lot Dimensions	Typical lot dimensions to scale; dimensions of all corner lots and lots of curvilinear sections of streets; each lot and block numbered individually; each lot labeled with its individual lot acreage and square footage.	<b>✓</b>	
Land Use and Zoning Classification (Each Area)	If plat includes land for which multi-family, commercial, industrial or mixed use is proposed, such areas shall be clearly designated together with existing zoning classification and status of zoning change, if any.	<b>~</b>	
Special Development Areas	Appropriate information that sufficiently details the proposed subdivision within any special development area, such as:  Hillside Floodplain		
On and Off-Site Improvements	The proposed on and off site improvements including water supply systems, sanitary sewer systems and stormwater drainage.	<b>✓</b>	
Access and Approaches	Width, spacing and location of all proposed approaches to the subdivision with type (example: full approach, right in/right out approach) of approach indicated.	<b>✓</b>	
Proposed Utility Methods	<ul> <li>(A) Sewage Disposal: Such evidence relative to the design flows within the subdivision, and operation of the sanitary sewage facilities proposed. A statement as to the type of facilities proposed shall appear on the preliminary plat.</li> <li>(B) Water Supply: Such evidence relative to the design, operation, volume and quality of the water supply and facilities proposed. A statement as to the type of facilities proposed shall appear on the preliminary plat.</li> <li>(C) Stormwater Disposal: Such evidence relative to the design and operation of the stormwater disposal system. A statement as to the type of facilities proposed, and an indication of all areas to be used for treatment/disposal shall appear on the preliminary plat. All stormwater design shall comply with the city's most recent "Stormwater Management Manual" as adopted by council as of the date of preliminary plat application submittal.</li> <li>(D) Irrigation System: A statement describing the proposed irrigation system, consistent with section 10-07-12 of the Caldwell City Code, shall appear on the preliminary plat.</li> </ul>	<b>✓</b>	



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PRELIMINARY PLAT	CONTENT cont.	Applicant	Staff
Acknowledgement	Note acknowledging that, to the best of the preparer's knowledge, the preliminary plat meets all requirements of city code; or if said plat does not meet all requirements then the plat has been submitted as a planned unit development and any and all requested exceptions have been listed in detail as part of the planned unit development application or it is not a planned unit development but any exceptions as allowed in this chapter have been noted on the preliminary plat and specifically requested as a part of the application.	<b>&gt;</b>	

## **SECTION III**

LANDSCAPE PLAN C	ONTENT (CCC 10-07-03)	Applicant	Staff
Plan Preparation	Landscaping plans shall be prepared by a landscape architect, a landscape designer or a qualified nursery person; Landscape plans shall be stamped by a licensed landscape architect.	<b>V</b>	
Plan Size	Detailed plan at a scale no smaller than one inch equals fifty feet (1" = 50')		
Streets, Setbacks and Easements	Show all streets, setbacks, and easements, Streets shall be identified by name.  Dimension and label all right-of-way, setbacks, and easements	<b>~</b>	
Sight Visibility Triangles	Show and label all sign visibility triangles.	<b>/</b>	
Storm Water Facilities and Berms	Show all storm water facilities and berms. Indicate berm heights, slopes and proposed landscaping	<b>~</b>	
Off-Street Parking & Bicycle Parking	<ul> <li>A note listing the required number of parking spaces and bicycle parking spaces.</li> <li>A note listing the provided number of parking spaces and bicycle parking spaces. The provided number of parking spaces and bicycle parking spaces shall equal or exceed the required number of parking spaces and bicycle parking spaces.</li> <li>Circulation area required to serve the parking spaces with typical dimensions.</li> </ul>	~	
Existing Trees and/or Shrubs	Location of all existing trees and shrubs, and the approximate size and type of any existing trees and shrubs. Indicate by note which trees and/or shrubs will remain, if any.	<b>✓</b>	
Existing and Proposed Structures	Location of all existing and proposed structures and a note of whether or not the existing structures will remain	<b>✓</b>	
Pathways	Location, width, and type of pathways, along with identification of all required pathway materials and landscaping callouts:  • Micro Pathways  • Major Pathways  • Public Pathways  • Regional Pathways  • Indian Creek Corridor Pathways (if applicable)	<b>✓</b>	
Open Space Exhibit	All open space clearly delineated using colored shading so it is readily identifiable. The open space exhibit shall contain a table identifying:  The percentage and acreage of each individual areas of open space and if the open space is being calculated as qualified open space  The total percentage and acreage of code required open space and qualifying open space in relationship to the gross area of the project  The total percentage and acreage of proposed open space and qualifying open space in relationship to the gross area of the project	~	
Public Amenities	Location, size, and types of new structures for recreational use (i.e., gazebos, water		



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LANDSCAPE PLAN C	ONTENT (CCC 10-07-03)	Applicant	Staff
School Bus Stops	Location of school bus stop areas within a common lot or common easement		
Public Transit Stops	Location of any public transit		
Street Landscape Buffers	Location and width of all street landscape buffers. Include the location of all sod, trees, shrubs, plantings, and other materials proposed.	<b>~</b>	
Landscape Buffers Between Land Uses	Location and width of all landscape buffers between different land uses. Include the location of all sod, trees, shrubs, plantings, and other materials proposed.	<b>~</b>	
Parking Lot Landscaping	Location and size of all landscape islands within parking lots, Include the location of all landscaping materials proposed		
Trash Enclosures	Location of all trash enclosures, to include details about screening and landscaping		
Fencing	Location, height, color, and materials for all existing or proposed fencing		
Other Landscape	Provide location, size, type and description of all other landscape improvements such		
Amenities	as berms, decorative rock, boulders, etc.		
Landscape Schedule	Provide a table listing all of the locations, descriptions, types and numbers of landscaping products to be installed.		

## **SECTION IV**

GENERAL PROJECT INFORMATION	l				
Type of land uses within subdivision:	Residential only	Commercial only	Industrial only		
	Mixed-use (mix of re	esidential and non-residenti	(al uses)		
Has your development / subdivision name, street names, and lot and block numbers been approved by the City of Caldwell Mapping Division?	Yes No  If yes, have you made a approved by Mapping?		ns to the previously approved pre-plat		
Will the subdivision be phased?	Yes No If yes, how many phases are proposed? 5				
Development timeline for full build out?					
LAND USE AND ZONING INFORMAT	TION				
	Zoning Designation	Comp Plan Designation	1 Land Use		
Existing (Subject Property)					
Proposed (Subject Property)					
North of Site					
South of Site					
East of Site					
West of Site					



PROJECT SPECIFIC INF	FORMA	NOITA								
		Number of Lots			Acres		Percent of "Net" Acres  Net acreage is the total acreage minus any public streets and public rights of way			
Residential Lots										
Commercial Lots										
Industrial Lots										
Common Lots										
EXISTING AND PROPOS	SED B									
		EXIS	of STING dings	# o PROPO buildii	SED	# of EXISTING dwelling units	# o PROPO dwelling	SED	Max. Building Height	Total GROSS square footage of buildings
Residential:										
Single-family (detached) he										
Townh										
Two-family (du										
Four, five and six f										
(fourplex, fiveplex, and six										
Multi-family (7 or > dw	ellina									
units) in a single bu										
Commercial						N/A	N/A	4		
Industrial						N/A	N/A			
Type of Commercial or Industrial Buildings:					;	Single-tenant buildi	ing(s)	Multi-te	enant buildings	
DENSITY AND OPEN SE	PACE	Compi				C 10-07-05)				
Dwelling units per gross acre (Density):			Max	k. Allowed					Proposed	
Total Open Space	% Required							% Proposed		
Total "Qualifying" Open Space			%	Required					% Proposed	
Included	highligh	nted and	d labeled	for qualify	ing op	Exhibit showing all en space, and table fying open space.	areas of c e with brea	ppen spa akdown,	ace highlighted, square footage	all areas , percentage



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PARKING, LOADING AND PEDEST	RIAN AMENITIES (CCC 10-02-05)	
Description	Min. Required	Proposed
Electric vehicle parking spaces		
Off-street parking spaces		
Commercial loading spaces		
Industrial loading spaces		
Bicycle parking spaces:		
Describe any public transportation facilities that will be provided in accordance with (CCC 10-02-05 B)		
Public Amenities:	Provide a description of the type of pub	olic amenities proposed:
LANDSCAPING AND PATHWAYS	CCC Chapter 10, Article 7)	
Landscaping: (Please check all locations where landscaping will be provided)	Parking lot Common areas  Between different land uses Path  Other	Street landscape buffers nways Around building exterior
Major Pathways	Describe location, width, and landscaping:	
Micro Pathways	Describe location, width, and landscaping	
Public Pathways (per Bicycles and Pathways Master Plan)	Describe location, width, landscaping, and	any proposed fencing:



STREET LANDSCAPE	BUFFERS (C	CC 10-07-08)								
Location (Enter Street Name)	Min. Width Required	Proposed Width	% of Sod Proposed	# of Trees Proposed			# of Shrubs roposed	Min. Shrub Spacing (in feet)		
BUFFERS BETWEEN LA	AND USES (C	CCC 10-07-10)								
Location (If not required, put N/A)	Min. Width Required	Proposed Width	% of Sod Proposed	# of Trees Proposed	Spa	-	# of Shrubs roposed	Min. Shrub Spacing (in feet)		
North Property Line								(		
South Property Line										
East Property Line										
West Property Line										
PUBLIC SIDEWALKS										
Location (Street Name)		Min. Width Required	Proposed Width	I	T	ype of Side	walk			
					ndering	Attac		Detached		
					ndering		Attached Detac			
					ndering	Attac		Detached		
				Meai	ndering	Attac	ned	Detached		
UTILITIES, INFRASTRU	CTURE, AND	PUBLIC SERV	ICES INFORMA	TION						
		Indiv	vidual Domestic W	/ell – How Man	ıy?					
			tralized Public Wa							
Domestic Water:		City Municipal Water System								
Domocile Water.		N/A								
		Nearest Water Line Connection:								
Individual Septic										
Sewer (Wastewater):			Municipal Sewer							
ocwer (wastewater).		N/A								
		Nearest Sewer Line Connection:								
		Surf								
	Irrigation Well									
			ssurized							
Irrigation:		Grav								
		N/A								
		Nearest Irrigation Connection:								
		Irrigation Dis	urict:							



		Swales					
0.	Ponds						
Stormwater:	Borrow Ditches Other, Explain:						
		Other, Explain	•				
Stormwater Management:	Does the	e site disturb on	e or more acres of land? Yes No				
Fire Suppression Water Supply Source:							
Sources of Surface Water on or Nearby Properties (i.e., creeks, ditches, canals, lake, etc.):							
		Street Frontag	е				
Type of Site Access:		Easement Wic	Ith: Instrument #				
Street(s) Providing Access:							
Will Secondary Access for Fire be Provided:							
		Public					
lutaria di Danada.	Private						
Internal Roads:	Internal Circulation						
	Road User's Maintenance Agreement Inst#						
School Districts Serving this Legation:	Caldwell School District						
School Districts Serving this Location:	Vallivue School District						
SPECIAL ON-SITE CHARACTERISTICS	3						
	Yes	No	If yes, explain:				
Areas of Critical Environmental Concern?							
Evidence of Erosion?							
Fish Habitat?							
Floodplain?							
Riparian Vegetation?							
Steep Slopes?							
Streams/Creeks?							
Unique Animal/Plant Life?							
Unstable Soils?							
Wildlife Habitat?							
Historic Buildings or Features?							
Thistoric Buildings of T cutures:							



Describe characte	e any other unique site ristics:					
ACKNO	DWLEDGEMENT					
<b>✓</b>	I acknowledge that all items of have been submitted as single-			mittal package and th	at all documents	
<b>~</b>	I acknowledge that the applicant or the applicant's representative is responsible for the physical posting of all subject sites prior to the public hearings, and for providing affidavit of proof of posting in accordance with Caldwe City Codes; and					
<b>~</b>	I acknowledge that the applicanthis application.	t or the applicant's re	epresentative IS R	EQUIRED to attend a	ll public hearings for	
ı	certify this document has been a		•	e: Agent / Representativ	10	
ı	□ Property Owner as the Applic	ant 🔽	Property Owner's	Agent / Representativ	/e	
,	Applicant / Applicant's Representa	ative Printed Name	Date			
-	Applicant / Applicant's Representa	 ative Signature				





## PLANNED-UNIT DEVELOPMENT

Project Name:	File #:
Applicant/Agent:	

Applicant (√)	Please provide the following REQUIRED documentation:	Staff (√)
	PUD Details Form	
	Narrative fully describing the proposed use/request	
	Recorded warranty deed for the subject property	
<b>~</b>	Detailed Site Plan	
	Preliminary Plat (if applicable)	
	Signed Property Owner Acknowledgement (if applicable)	
	Vicinity map, showing the location of the subject property	
	Traffic Study (if applicable)	
	Landscape Plan (if applicable)	
	Neighborhood Meeting sign-in sheet	
<b>~</b>	All of the above items shall be submitted in 8 ½ x 11 paper format AND in electronic format (preferably PDF or Word) on either a jump drive or CD. Please	
	be aware the jump drive or CD will become part of the file and will not be	
	returned.	
	Fee	

STAFF USE ONLY:
Date Application Received:
Received by:
Proposed Hearing Date:
Hearing Body:



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## DEVELOPMENT AGREEMENT CHECKLIST

The following items shall be included in any development agreement modification submittal. Additional information may be required, as indicated in your roundtable (pre-app) meeting or upon official review of the application and/or plans. Please check the box for each item listed below to confirm submission of the item listed.

## **SECTION I**

SUBMITTAL DOCUM	ENTS & RELATED PLANS	Applicant	Staff
Master Land Use	Copy of completed, signed and dated application		
Application		•	
Application Checklist	Copy of completed, signed and dated checklist	<b>V</b>	
Project Narrative	Narrative fully describing the proposed request, including but not limited to the reason for the development agreement modification.	<b>✓</b>	
Proof of Property Ownership	Recorded Warranty Deed for the subject property showing proof of ownership, or evidence of property interest to subject property		
Legal Description of Property	Attach a legal description of the property including metes and bounds to the centerline of all adjacent rights of ways. All legal descriptions shall be certified by a land surveyor registered to the State of Idaho.		
Property Owner Acknowledgement	If the signatory of the application is not the owner of the property, a notarized statement (property owner acknowledgement) must be signed by the legal owner of record and submitted with the application	✓	
Vicinity Map (Scaled)	Scaled vicinity map showing the location of the subject property.	✓	
Original Development Agreement	Provide a copy of the original development agreement that was approved and recorded		
Draft of Development Agreement Modifications	Provide a draft of the original development agreement to be modified with all proposed text deletions shown in strike-out format, and all proposed text additions shown in underlined format.		
	REMENTS (Development agreement modifications where a new, nent agreement is proposed or required)	Applicant	Staff
Property Owner Information	Include the property owner information, including the mailing address information to be included in the new development agreement.		
Legal Description of Property	Attach a legal description of the property subject to the new development agreement. Include:  • A metes and bounds description, stamped and signed by a registered professional land surveyor; AND  • A scaled exhibit map showing the boundaries of the legal description in compliance with the requirements of the Idaho State Tax Commission Property Tax Administrative Rules IDAPA 35.01.03.225.oh.h: OR  • If property is a lot and block within an existing subdivision, include a description of the lot and block along with an exhibit map/plat depicting the location of said lot and block	✓included □ N/A	



Draft of NEW	Provide a draft of the new development agreement that is being proposed	☐ Included	
Development		□ N/A	
Agreement			

SECTION II			
NERAL INFORMATION			
ginal Project Name			
ginal Annexation / Rezone Case mber:			
ginal Ordinance #, Instrument # d Recording Date:	Ordinance #:	County Instrument #:	County Recording Date:
ginal Development Agreement – te of City Council approval, trument # and Recording Date	Date of City Council Approval:	County Instrument #:	County Recording Date:
I acknowledge that addition understanding of the requirements have been surely acknowledge that the application hearings for this application	icant or the applicant's represe า.	h-resolution copies; and uested or required in or entative IS REQUIRED to	d rder to have a full
i certify this document has	been acknowledged, signed a	nd dated by the:	
☐ Property Owner as the A	Applicant □ Propert	y Owner's Agent / Repres	sentative
Applicant / Applicant's Rep	resentative Printed Name	Date	
Applicant / Applicant's Rep	resentative Signature		



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## SUBDIVISION PRELIMINARY PLAT CHECKLIST

The following items shall be included in any application submittal. Additional information may be required, as indicated in your roundtable (pre-app) meeting or upon official review of the plans. Please check the box for each item listed below to confirm submission of the item listed.

### **SECTION I**

SUBMITTAL DOCUM	IENTS & RELATED PLANS	Applicant	Staff
Master Land Use Application	Copy of completed, signed and dated application	<b>~</b>	
Application Checklist	Copy of completed, signed and dated checklist	<b>✓</b>	
Property Owner Acknowledgement	If the signatory of the application is not the owner of the property, a notarized statement (property owner acknowledgement) must be signed by the legal owner of record and submitted with the application	<b>~</b>	
Proof of Property Ownership	Recorded Warranty Deed for the subject property showing proof of ownership, or evidence of property interest to subject property	<b>~</b>	
Legal Description of Property	Attach a legal description of the property including metes and bounds to the centerline of all adjacent rights of ways. All legal descriptions shall be certified by a land surveyor registered to the State of Idaho.	<b>~</b>	
Neighborhood Meeting Information	<ul> <li>The verification shall include: <ul> <li>A copy of the letter mailed by the applicant (Min. 15 days prior to meeting)</li> <li>A copy of the 500' mailing list indicating all notified owners, residents and associations</li> <li>A copy of the sign-up sheet from the meeting, with your signature</li> </ul> </li> <li>Note: Neighborhood meetings must have been held within four (4) months of application submission.</li> </ul>	~	
Photographs	Photographs of existing site conditions	<b>✓</b>	
Project Narrative	Narrative fully describing the application request(s), the purpose of the development, existing site conditions, and what is being proposed.	<b>✓</b>	
Concept Building Elevations	Colored concept elevations of all four (4) sides of buildings, indicating building heights, colors, materials, windows, doors, and architectural features.		
Site Plan (Scaled)	Site plan, drawn to scale, showing location of all property lines, existing and proposed buildings, utilities, setbacks, easements, and streets with street names.	<b>✓</b>	
Preliminary Plat	High resolution preliminary plat, to scale. See requirements for plan content in <b>Section II below</b>	<b>~</b>	
Landscape Plan	High resolution landscape plan, to scale. See requirements for landscape plan contents in Section III below	<b>✓</b>	



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## **SECTION II**

PRELIMINARY PLAT	CONTENT	Applicant	Staff
Plans to Scale	All mapped data for the same plat shall be drawn at a scale suitable to ensure the clarity of all lines, bearings and dimensions, said scale typically being one hundred feet to an inch (100' = 1"). Whenever practical, scales shall be adjusted to produce an overall drawing measuring eighteen inches by twenty- four inches (18" x 24"), but not exceeding forty-two inches by sixty inches (42" x 60").	~	
Subdivision Name and Location	<ul> <li>The proposed subdivision name and location shall be provided on the plat and shall meet the following:         <ul> <li>Said name shall be approved by the City Mapping Department and shall not being a duplicate name of any other recorded subdivision within Canyon County or any of the cities in Canyon County;</li> <li>Location of subdivision by section, township and range; reference by dimension and bearing to a combination of two (2) section corners, quarter section corners, or recorded monuments. (Ord. 3374, 12-6-2021)</li> </ul> </li> </ul>	~	
Contact Information	Name, address and phone number of property owner(s), subdivider, engineer, planner, and surveyor who prepared the plat, and any other professional persons involved in the subdivision.	<b>✓</b>	
Scale, North Arrow, and Plan Preparation Date	Scale, north arrow and date of preparation including dates of any subsequent revisions.	<b>~</b>	
Vicinity Map (Scaled)	Vicinity map drawn to a maximum scale of one inch equals five hundred feet (1" = 500'), clearly showing the proposed subdivision or planned unit development configuration in relationship to, as well as, identifying and showing lot lines and street connections of all adjacent subdivisions, all arterial streets, all collector streets and bodies of water.	~	
Topography	Topography based on NAVD 88 datum shown on the same map as the proposed subdivision layout. Contour lines shown at five foot (5') intervals where land slope is greater than ten percent (10%) and at two foot (2') intervals where land slope is ten percent (10%) or less, referenced to an established bench mark, including location and elevation.	<b>~</b>	
Existing Water	Location of existing water wells and type, streams, canals, irrigation laterals, drainage facilities, private ditches, washes, lakes and other water features; direction of flow; regulatory floodplain and floodway boundaries if any; and location and extent of known areas subject to inundation if any.	<b>✓</b>	
Streets and other Important Features	Location, widths and names of all existing streets and location, arrows indicating direction of slopes, type of surface and existence of any curb, gutter and/or sidewalks. Other important features such as railroads, utility rights of way and easements of public record, public areas, permanent structures to remain including water wells, and municipal corporation lines within or adjacent to the tract.	~	
Recorded Subdivisions with Common Boundaries	Name, book, page number and lot line layout of any recorded adjacent subdivision having common boundary with the tract.	<b>~</b>	
Table Schedule (see attached example)	Table Schedule of:  Existing zoning classification of the tract with any requested zoning changes.  Total acreage of the entire subdivision  Total number of buildable lots by land use type.  Total number of common lots.  Total gross acreage  Average buildable lot size  Dwelling units per gross acre.	~	



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PRELIMINARY PLAT	CONTENT cont.	Applicant	Staff
Subdivision Boundary	The subdivision boundary with dimensions and bearings shall be based on an actual recorded field survey, performed within six (6) months of the preliminary plat application, and shall include the professional land surveyor stamp. Boundary problems shall be resolved prior to preliminary plat submittal. Stamping of the preliminary plat by the professional land surveyor pertains only to the boundary survey and should be noted as such.	<b>✓</b>	
Public dedications of rights of way or easements	Proposed location, width, dimensions and bearings, and use of all proposed easements within the subdivision. All existing easements with location, width, dimensions, bearings, use and instrument numbers. Designation of all land to be dedicated or reserved for public use with purpose indicated.	<b>✓</b>	
Names, Addresses, and Tax Parcel Numbers	Names, addresses and tax parcel numbers for all property owners within three hundred feet (300') of the exterior boundary of the subdivision, displayed visually on the plat in the appropriate locations.	<b>✓</b>	
Utilities	Storm drains and water supply mains, both proposed and existing, within and immediately adjacent to the subdivision. Approximate location of existing sanitary sewer facilities, manholes, lines, and any other sewer related facilities within and adjacent to the subdivision.	<b>✓</b>	
Proposed Street Layout	Proposed street layout, including location, width and proposed names of streets, common driveways, alleys, major pathways, micro pathways and easements; pedestrian and vehicular connections to adjoining properties.	<b>✓</b>	
Lot Dimensions	Typical lot dimensions to scale; dimensions of all corner lots and lots of curvilinear sections of streets; each lot and block numbered individually; each lot labeled with its individual lot acreage and square footage.	<b>✓</b>	
Land Use and Zoning Classification (Each Area)	If plat includes land for which multi-family, commercial, industrial or mixed use is proposed, such areas shall be clearly designated together with existing zoning classification and status of zoning change, if any.	<b>~</b>	
Special Development Areas	Appropriate information that sufficiently details the proposed subdivision within any special development area, such as:  Hillside Floodplain		
On and Off-Site Improvements	The proposed on and off site improvements including water supply systems, sanitary sewer systems and stormwater drainage.	<b>✓</b>	
Access and Approaches	Width, spacing and location of all proposed approaches to the subdivision with type (example: full approach, right in/right out approach) of approach indicated.	<b>✓</b>	
Proposed Utility Methods	<ul> <li>(A) Sewage Disposal: Such evidence relative to the design flows within the subdivision, and operation of the sanitary sewage facilities proposed. A statement as to the type of facilities proposed shall appear on the preliminary plat.</li> <li>(B) Water Supply: Such evidence relative to the design, operation, volume and quality of the water supply and facilities proposed. A statement as to the type of facilities proposed shall appear on the preliminary plat.</li> <li>(C) Stormwater Disposal: Such evidence relative to the design and operation of the stormwater disposal system. A statement as to the type of facilities proposed, and an indication of all areas to be used for treatment/disposal shall appear on the preliminary plat. All stormwater design shall comply with the city's most recent "Stormwater Management Manual" as adopted by council as of the date of preliminary plat application submittal.</li> <li>(D) Irrigation System: A statement describing the proposed irrigation system, consistent with section 10-07-12 of the Caldwell City Code, shall appear on the preliminary plat.</li> </ul>	<b>✓</b>	



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PRELIMINARY PLAT	CONTENT cont.	Applicant	Staff
Acknowledgement	Note acknowledging that, to the best of the preparer's knowledge, the preliminary plat meets all requirements of city code; or if said plat does not meet all requirements then the plat has been submitted as a planned unit development and any and all requested exceptions have been listed in detail as part of the planned unit development application or it is not a planned unit development but any exceptions as allowed in this chapter have been noted on the preliminary plat and specifically requested as a part of the application.	<b>&gt;</b>	

#### **SECTION III**

LANDSCAPE PLAN C	CONTENT (CCC 10-07-03)	Applicant	Staff		
Plan Preparation	<b>~</b>				
Plan Size	Detailed plan at a scale no smaller than one inch equals fifty feet (1" = 50')				
Streets, Setbacks and Easements	Show all streets, setbacks, and easements, Streets shall be identified by name.  Dimension and label all right-of-way, setbacks, and easements	<b>~</b>			
Sight Visibility Triangles	Show and label all sign visibility triangles.	<b>/</b>			
Storm Water Facilities and Berms	Show all storm water facilities and berms. Indicate berm heights, slopes and proposed landscaping	<b>~</b>			
Off-Street Parking & Bicycle Parking	<ul> <li>A note listing the required number of parking spaces and bicycle parking spaces.</li> <li>A note listing the provided number of parking spaces and bicycle parking spaces. The provided number of parking spaces and bicycle parking spaces shall equal or exceed the required number of parking spaces and bicycle parking spaces.</li> <li>Circulation area required to serve the parking spaces with typical dimensions.</li> </ul>	<b>✓</b>			
Existing Trees and/or Shrubs	Location of all existing trees and shrubs, and the approximate size and type of any existing trees and shrubs. Indicate by note which trees and/or shrubs will remain, if any.	<b>✓</b>			
Existing and Proposed Structures	Location of all existing and proposed structures and a note of whether or not the existing structures will remain	<b>✓</b>			
Pathways	Location, width, and type of pathways, along with identification of all required pathway materials and landscaping callouts:  • Micro Pathways  • Major Pathways  • Public Pathways  • Regional Pathways  • Indian Creek Corridor Pathways (if applicable)	~			
Open Space Exhibit	All open space clearly delineated using colored shading so it is readily identifiable.     The open space exhibit shall contain a table identifying:	~			
Public Amenities					



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LANDSCAPE PLAN C	ONTENT (CCC 10-07-03)	Applicant	Staff
School Bus Stops	Location of school bus stop areas within a common lot or common easement		
Public Transit Stops	Location of any public transit		
Street Landscape	Location and width of all street landscape buffers. Include the location of all sod,	./	
Buffers	trees, shrubs, plantings, and other materials proposed.	•	
Landscape Buffers	Location and width of all landscape buffers between different land uses. Include the	. 🌶	
Between Land Uses	location of all sod, trees, shrubs, plantings, and other materials proposed.		
Parking Lot	Location and size of all landscape islands within parking lots, Include the location of		
Landscaping	all landscaping materials proposed		
Trash Enclosures	Location of all trash enclosures, to include details about screening and landscaping		
Fencing	Location, height, color, and materials for all existing or proposed fencing		
Other Landscape	Provide location, size, type and description of all other landscape improvements such		
Amenities	as berms, decorative rock, boulders, etc.	<b>.</b>	
Landscape Schedule	Provide a table listing all of the locations, descriptions, types and numbers of landscaping products to be installed.		

#### **SECTION IV**

GENERAL PROJECT INFORMATION	l							
Type of land uses within subdivision:	Residential only	Residential only Commercial only Industrial only						
	Mixed-use (mix of re	sidential and non-resident	ial uses)					
Has your development / subdivision name, street names, and lot and block numbers been approved by the City of Caldwell Mapping Division?	Yes No  If yes, have you made a approved by Mapping?		ns to the previously approved pre-plat					
Will the subdivision be phased?	Yes No If yes, how many phases are proposed? 5							
Development timeline for full build out?								
LAND USE AND ZONING INFORMAT	rion							
	Zoning Designation	Comp Plan Designation	n Land Use					
Existing (Subject Property)								
Proposed (Subject Property)								
North of Site								
South of Site								
East of Site								
West of Site								



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PROJECT SPECIFIC INFO	ORMATIC	N							
		Num	Number of Lots		Acres		Percent of "Net" Acres  Net acreage is the total acreage minus any public streets and public rights of		
								way	
Residential Lots									
Commercial Lots									
Industrial Lots									
Common Lots									
EXISTING AND PROPOSI	ED BUIL	DING DAT		·					
		# of KISTING uildings	# o <sup>o</sup> PROPO buildii	SED	# of EXISTING dwelling units	# o PROPC dwelling	SED	Max. Building Height	Total GROSS square footage of buildings
Residential:									
Single-family (detached) hor									
Townhor									
Two-family (dup									
Three-family residential (trip									
Four, five and six far (fourplex, fiveplex, and sixp									
Multi-family (7 or > dwel									
units) in a single build									
Commercial					N/A	N/A	4		
Industrial					N/A	N/A	4		
Type of Commercial or Industrial Buildings:				:	Single-tenant build	ing(s)	Multi-te	enant buildings	
DENSITY AND OPEN SPA	ACE (Cor				C 10-07-05)				
Dwelling units per gross acre (Density):		Ma	x. Allowed					Proposed	
Total Open Space		%	% Required			% Proposed			
Total "Qualifying" Open Space		%	% Required					% Proposed	
Included h	ighlighted	and labeled	l for qualify	ring op	Exhibit showing all en space, and table ving open space.				



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PARKING, LOADING AND PEDESTRIAN AMENITIES (CCC 10-02-05) Description Min. Required **Proposed** Electric vehicle parking spaces Off-street parking spaces Commercial loading spaces Industrial loading spaces Bicycle parking spaces: Describe any public transportation facilities that will be provided in accordance with (CCC 10-02-05 B) Public Amenities: Provide a description of the type of public amenities proposed: LANDSCAPING AND PATHWAYS (CCC Chapter 10, Article 7) Landscaping: (Please check all locations where landscaping will be Parking lot Common areas Street landscape buffers provided) Between different land uses Pathways Around building exterior Other Major Pathways Describe location, width, and landscaping: Micro Pathways Describe location, width, and landscaping Public Pathways Describe location, width, landscaping, and any proposed fencing: (per Bicycles and Pathways Master Plan)



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STREET LANDSCAPE I	BUFFERS (C	CC 10-07-08)									
Location (Enter Street Name)	Min. Width Required	Proposed Width	% of Sod Proposed	# of Trees Proposed	Min. Tree Spacing (in feet)	# of Shrubs Proposed	Min. Shrub Spacing (in feet)				
BUFFERS BETWEEN L	AND USES (C	CC 10-07-10)									
Location (If not required, put N/A)	Min. Width Required	Proposed Width	% of Sod Proposed	# of Trees Proposed	Min. Tree Spacing (in feet)	# of Shrubs Proposed	Min. Shrub Spacing (in feet)				
North Property Line							(				
South Property Line											
East Property Line											
West Property Line											
PUBLIC SIDEWALKS											
Location (Street Name)		Min. Width Required	Proposed Width		Type o	f Sidewalk					
				Mean		Attached	Detached				
				Mean		Attached	Detached				
				Mean	•	Attached	Detached				
				Mean	dering	Attached	Detached				
UTILITIES, INFRASTRU	CTURE, AND	PUBLIC SERV	ICES INFORMA	TION							
		Indiv	vidual Domestic W	ell – How Many	?						
		Cent	tralized Public Wa	ter System							
Domestic Water:		City	Municipal Water S	System							
Domociic Water.		N/A									
		Nearest Wate	r Line Connectio	n:							
			ridual Septic								
Cower (Mestewater)			Municipal Sewer								
Sewer (Wastewater):		N/A									
		Nearest Sewe	er Line Connection	on:							
		Surfa	ace								
			ation Well								
			surized								
Irrigation:		Grav	/ity								
		N/A									
			Nearest Irrigation Connection:								
		Irrigation Dis									



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		Swales				
		Ponds				
Stormwater:		Borrow Ditche				
		Other, Explain	1:			
Stormwater Management:	Does the	site disturb on	e or more acres of land? Yes No			
Fire Suppression Water Supply Source:						
Sources of Surface Water on or Nearby Properties (i.e., creeks, ditches, canals, lake, etc.):						
		Street Frontag	ge			
Type of Site Access:		Easement Wic	dth: Instrument #			
Street(s) Providing Access:						
Will Secondary Access for Fire be		Yes				
Provided:		No				
	Public					
Internal Roads:	Private Internal Circulation					
	Road User's Maintenance Agreement Inst#					
	Caldwell School District					
School Districts Serving this Location:		Vallivue Schoo				
SPECIAL ON-SITE CHARACTERISTICS	3					
	Yes	No	If yes, explain:			
Areas of Critical Environmental Concern?						
Evidence of Erosion?						
Fish Habitat?						
Floodplain?						
Riparian Vegetation?						
Steep Slopes?						
Streams/Creeks?						
Unique Animal/Plant Life?						
Unstable Soils?						
Wildlife Habitat?						
Historic Buildings or Features?						



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Describe character	any other unique site istics:					
ACKNO	WLEDGEMENT					
<b>~</b>	I acknowledge that all items o have been submitted as single-				ge and that all do	ocuments
<b>~</b>	I acknowledge that the applicar subject sites prior to the public City Codes; and					
<b>✓</b>	I acknowledge that the applicar this application.	t or the applicant's re	epresentative I	S REQUIRED to	attend all public	hearings for
ı	certify this document has been a  Property Owner as the Applic			/ the: er's Agent / Repr	esentative	
_		· · · · · · · · · · · · · · · · · · ·				
А	opplicant / Applicant's Represent	ative Printed Name	Date			
Ā	applicant / Applicant's Represent	ative Signature				





#### PLANNED-UNIT DEVELOPMENT

Project Name:	File #:
Applicant/Agent:	

Applicant (√)	Please provide the following REQUIRED documentation:	Staff (√)
	PUD Details Form	
	Narrative fully describing the proposed use/request	
	Recorded warranty deed for the subject property	
<b>~</b>	Detailed Site Plan	
	Preliminary Plat (if applicable)	
	Signed Property Owner Acknowledgement (if applicable)	
	Vicinity map, showing the location of the subject property	
	Traffic Study (if applicable)	
	Landscape Plan (if applicable)	
	Neighborhood Meeting sign-in sheet	
<b>~</b>	All of the above items shall be submitted in 8 ½ x 11 paper format AND in electronic format (preferably PDF or Word) on either a jump drive or CD. Please	
	be aware the jump drive or CD will become part of the file and will not be	
	returned.	
	Fee	

STAFF USE ONLY:
Date Application Received:
Received by:
Proposed Hearing Date:
Hearing Body:



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### DEVELOPMENT AGREEMENT CHECKLIST

The following items shall be included in any development agreement modification submittal. Additional information may be required, as indicated in your roundtable (pre-app) meeting or upon official review of the application and/or plans. Please check the box for each item listed below to confirm submission of the item listed.

#### **SECTION I**

SUBMITTAL DOCUM	ENTS & RELATED PLANS	Applicant	Staff
Master Land Use	Copy of completed, signed and dated application		
Application		•	
Application Checklist	Copy of completed, signed and dated checklist	<b>V</b>	
Project Narrative	Narrative fully describing the proposed request, including but not limited to the reason for the development agreement modification.	<b>✓</b>	
Proof of Property Ownership	Recorded Warranty Deed for the subject property showing proof of ownership, or evidence of property interest to subject property		
Legal Description of Property	Attach a legal description of the property including metes and bounds to the centerline of all adjacent rights of ways. All legal descriptions shall be certified by a land surveyor registered to the State of Idaho.	✓	
Property Owner Acknowledgement	If the signatory of the application is not the owner of the property, a notarized statement (property owner acknowledgement) must be signed by the legal owner of record and submitted with the application	✓	
Vicinity Map (Scaled)	Scaled vicinity map showing the location of the subject property.	✓	
Original Development Agreement	Provide a copy of the original development agreement that was approved and recorded		
Draft of Development Agreement Modifications	Provide a draft of the original development agreement to be modified with all proposed text deletions shown in strike-out format, and all proposed text additions shown in underlined format.	□ Included N/A	
	REMENTS (Development agreement modifications where a new, nent agreement is proposed or required)	Applicant	Staff
Property Owner Information	Include the property owner information, including the mailing address information to be included in the new development agreement.		
Legal Description of Property	Attach a legal description of the property subject to the new development agreement. Include:  • A metes and bounds description, stamped and signed by a registered professional land surveyor; AND  • A scaled exhibit map showing the boundaries of the legal description in compliance with the requirements of the Idaho State Tax Commission Property Tax Administrative Rules IDAPA 35.01.03.225.oh.h: OR  • If property is a lot and block within an existing subdivision, include a description of the lot and block along with an exhibit map/plat depicting the location of said lot and block	✓included □ N/A	



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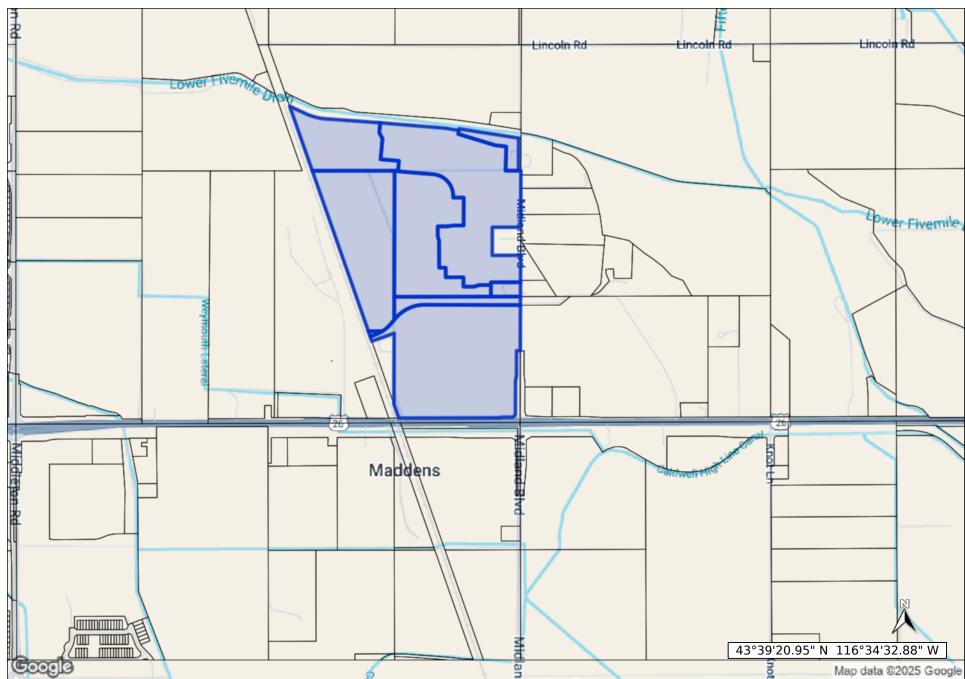
Draft of NEW	Provide a draft of the new development agreement that is being proposed	☐ Included	
Development		□ N/A	
Agreement			


SECTION II			
NERAL INFORMATION			
ginal Project Name			
ginal Annexation / Rezone Case mber:			
ginal Ordinance #, Instrument # I Recording Date:	Ordinance #:	County Instrument #:	County Recording Date:
ginal Development Agreement – le of City Council approval, trument # and Recording Date	Date of City Council Approval:	County Instrument #:	County Recording Date:
I acknowledge that addition understanding of the required lacknowledge that the application hearings for this application	cant or the applicant's represe	h-resolution copies; and uested or required in or entative IS REQUIRED to	der to have a full
·		·	
☐ Property Owner as the A	pplicant □ Propert	y Owner's Agent / Repres	sentative
Applicant / Applicant's Repr	esentative Printed Name	Date	
Applicant / Applicant's Repr			



# **Aviary Heights**Brighton Development





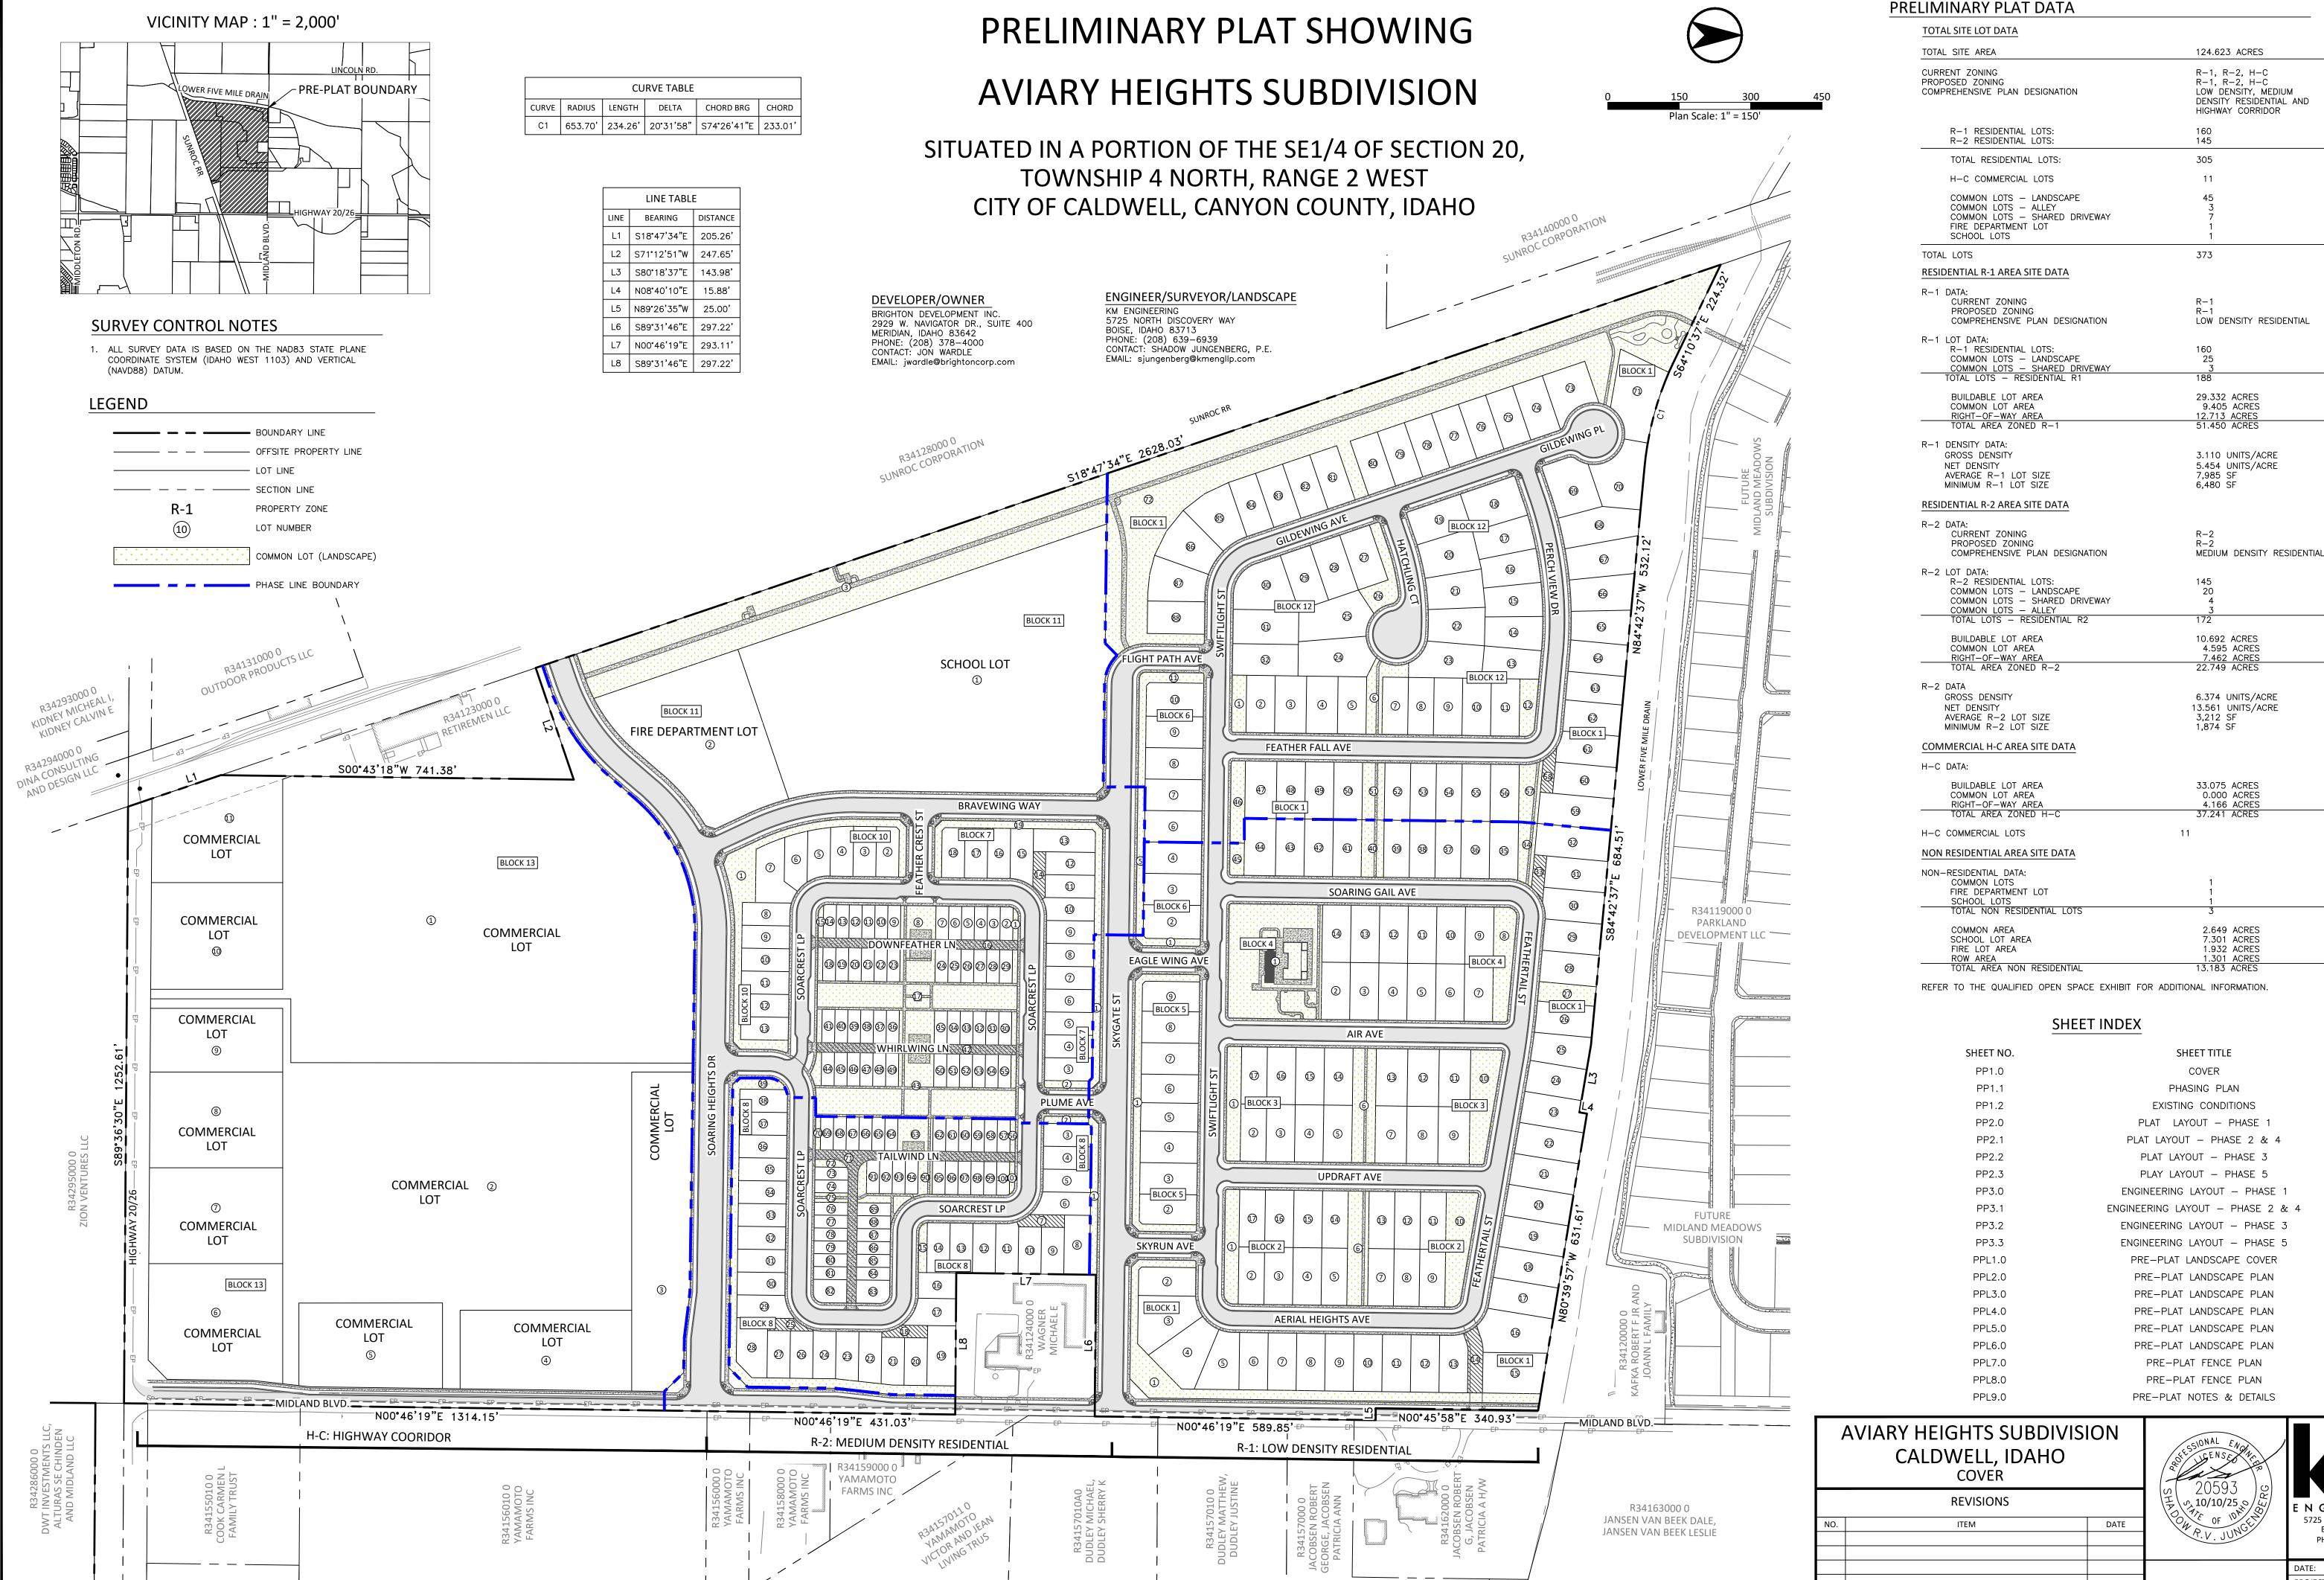

5725 NORTH DISCOVERY WAY BOISE, IDAHO 83713 PHONE (208) 639-6939 kmengllp.com

PROJECT: SHEET NO. PP1.0

































Because the project is residential in nature, floor plans that are consistent with the elevations will be submitted for building permits.

SOARING HEIGHTS DR 15 3,236 2 3178 454 0 91 91 SKYGATE ST 15 2,992 4 2876 0 0 82 82 FEATHER CREST ST 10 194 0 194 0 0 6 6 8 BRAVEWING WAY 10 1,606 1 1577 0 0 45 45 PLUME AVE 10 188 0 188 0 0 5 5 5 SOARCREST LP 10 5,466 3 5379 0 0 154 154 EAGLE WING AVE 10 202 0 202 0 0 6 6 8 SKYRUN AVE 10 202 0 202 0 0 6 6 8 SKYRUN AVE 10 3,140 7 2937 0 0 84 84 AERIAL HEIGHTS AVE 10 1,036 0 1036 0 0 30 30 UPDRAFT AVE 10 1,058 0 1058 0 0 30 30 AIR AVE 10 1,146 0 1146 0 0 35 35 FEATHER TAIL ST 10 1,804 2 1746 0 0 50 50 FEATHER FALL AVE 10 1,084 0 1084 0 0 31 31 31 PERCH VIEW DR 10 1,084 0 1084 0 0 31 31	BLOCK #	LOT #			SQ.FT.			REQ	EES PRVD
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									· ·
									<b>-</b>
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2									
2									
3	3							1	3
Fig.									
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7   19   1468	-								
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9	8	39			23130			5	19
9	-								
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9   63   70   745   0   0   0   0   9   9   72   9   940   0   0   0   0   0   9   9   72   9   940   0   0   0   0   0   0   9   9   9	9	43			34341			7	8
9 9 72 899								_	
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11 3 19988	9	101			702			0	0
12						_	_		
12			-				-	· ·	
TOTAL COMMON LOT TREES	12	12			4108			1	1
### PATHWAY CALCULATIONS  ### BLOCK # LOT # LOT # LF REQ PRVD REQ PRVD  1			FFC		6142			·	
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1									
2							+	_	-
1		6					+	-	· ·
9 17 1065 150 0 0 0 0 0 9 63 63 69 10 0 0 0 1 1 9 75 70 10 0 0 0 1 1 9 75 70 10 0 0 0 1 1 9 9 90 215 32 0 0 0 1 1 1 1 1 1 1 1 1 1 1 1 1 1 1 1							+ -		· ·
9 63 69 10 0 0 1 9 75 70 10 0 0 0 1 7TOTAL PATHWAY TREES  STREET CALCULATIONS  10' LOCAL LANDSCAPE BUFFER: (1) CLASS II TREE / 35 LF OR (1) CLASS I / 25 LF 20' COLLECTOR LANDSCAPE BUFFER: (1) TREE / 35 LF OR (1) CLASS I / 25 LF; (1) SHRUB / 7 LF; 3:1  20' COLLECTOR LANDSCAPE BUFFER: (1) TREE / 35 LF OR (1) CLASS I / 25 LF; (1) SHRUB / 7 LF; 3:1  21' MINDE AREFIRL LANDSCAPE BUFFER: (1) TREE / 35 LF OR (1) CLASS I / 25 LF; (1) SHRUB / 7 LF; 3:1  22' COLLECTOR LANDSCAPE BUFFER: (1) TREE / 35 LF OR (1) CLASS I / 25 LF; (1) SHRUB / 7 LF; 3:1  23' LANDSCAPE BERN MR. 2' HID!  23' LANDSCAPE BUFFER: (1) CLASS II OR II TREE / 35 LF, (1) SHRUB / 7 LF, AND (1) BOULDER / 75 LF, 3:1  33' LANDSCAPE BERN OR 3' WALL @ MIN. 30% OF LF  TURF GRASS NOT TO EXCEED 50% OF BUFFER ARAS  STREET NAME  BUFFER WIDTH (FT)  LF # OF DRIVES   LF - DRIVES   SHRUB ** ** TREES  MIDLAND BLVD.  20 2.627 2 2.524 361 0 101 102*  SOARING HEIGHTS DR 15 3.236 2 3178 454 0 91 91 91  SKYGATE ST 15 2.992 4 2876 0 0 882 82  FEATHER CREST ST 10 194 0 194 0 0 6 6 6  BRAVEWING WAY 10 1,606 1 1577 0 0 45 45  BRAVEWING WAY 10 188 0 188 0 0 185  SOARCREST LP 10 188 0 188 0 0 184 0 0 15 45  SOARCREST LP 10 194 0 202 0 202 0 0 15 45 15  SKYRIN AVE 10 202 0 202 0 0 0 6 6 6  SKYRIN AVE 10 1,038 0 1036 0 0 30 30  UPDRAFT AVE 10 1,146 0 1146 0 0 136 0 0 30 30  UPDRAFT AVE 10 1,146 0 1146 0 0 1364 0 0 35 33  SOARING GAIL AVE 10 1,038 0 1036 0 0 35 30  AIR AVE 10 1,1604 2 11746 0 0 5 5 5  FEATHER TRAIL AVE 10 1,084 0 1084 0 0 0 41 41  GILDEWING AVE 10 1,084 0 1084 0 0 0 19 9 9  FEATHER TRAIL AVE 10 1,084 0 1084 0 0 0 19 9 9  FLATCHILDRED TO THE TRAIL AVE 10 1,084 0 0 0 1679 0 0 0 19 9 9  FLIGHT PATH AVE 10 3566 0 3566 0 0 10 10 10				+			+ -	_	<del>-</del>
9   90   215   32   0   0   1						1	+ -		-
STREET CALCULATIONS						<b> </b>	+		-
10   LOCAL LANDSCAPE BUFFER: (1) CLASS    TREE   35    F OR (1) CLASS    25    F	TOTAL PATH	WAY TREES				1	1	97	105
STREET NAME	10' LOCAL LANDSCAPE E 20' COLLECTOR LANDSCA 25' MINOR ARTERIAL LAI LANDSCAPE BERM MIN. 2 35' HWY 20/26 LANDSC 3:1 LANDSCAPE BERM O TURF GRASS NOT TO EX	BUFFER: (1) CLASS II APE BUFFER: (1) TREE NDSCAPE BUFFER: (1) 2' HIGH APE BUFFER: (1) CLA OR 3' WALL @ MIN. 30 CCEED 50% OF BUFFER	TREE / 35 LF TREE / 3 SS II OR II % OF LF AREAS	OR (1) CLASS I , 5 LF OR (1) CLASS TREE / 35 LF, (1	/ 25 LF; (1) SHF S I / 25 LF; (1) ) SHRUB / 7 LF	SHRUB , AND (	/ 7 LF;	DER /	
SOARING HEIGHTS DR 15 3,236 2 3178 454 0 91 91 SKYGATE ST 15 2,992 4 2876 0 0 82 82 FEATHER CREST ST 10 194 0 194 0 0 6 6 8 BRAVEWING WAY 10 1,606 1 1577 0 0 45 45 45 PLUME AVE 10 188 0 188 0 0 5 5 5 SOARCREST LP 10 5,466 3 5379 0 0 154 154 EAGLE WING AVE 10 202 0 202 0 0 6 6 8 SKYRUN AVE 10 202 0 202 0 0 6 6 8 SKYRUN AVE 10 202 0 202 0 0 6 6 8 SWIFTLIGHT ST 10 3,140 7 2937 0 0 84 84 AERIAL HEIGHTS AVE 10 1,036 0 1036 0 0 30 30 UPDRAFT AVE 10 1,058 0 1058 0 0 30 30 AIR AVE 10 1,146 0 1146 0 0 33 33 33 SOARING GAIL AVE 10 1,236 0 1236 0 0 35 35 FEATHERTAIL ST 10 1,804 2 1746 0 0 50 50 FEATHER FALL AVE 10 1,084 0 1084 0 0 31 31 31 GILDEWING AVE 10 1,084 0 1084 0 0 31 31 31 GILDEWING AVE 10 1,504 2 1446 0 0 41 41 GILDEWING AVE 10 1,504 2 1446 0 0 9 9 9 HATCHLING CT 10 10 679 0 679 0 0 19 19 FILIGHT PATH AVE 10 356 0 356 0 0 10 10 10 10 10 10 10 10 10 10 10 10		. ,				REQ	PRVD	REQ	PRVD
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AERIAL HEIGHTS AVE 10 1,036 0 1036 0 0 30 30 UPDRAFT AVE 10 1,058 0 1058 0 0 30 30 AIR AVE 10 1,146 0 1146 0 0 33 33 33 SOARING GAIL AVE 10 1,236 0 1236 0 0 35 35 FEATHERTAIL ST 10 1,804 2 1746 0 0 50 50 FEATHER FALL AVE 10 1,342 0 1342 0 0 38 38 PERCH VIEW DR 10 1,084 0 1084 0 0 31 31 GILDEWING AVE 10 1,504 2 1446 0 0 41 41 GILDEWING PL 10 316 0 316 0 0 9 9 HATCHLING CT 10 356 0 356 0 0 10 10				-		_	+ -		
UPDRAFT AVE         10         1,058         0         1058         0         0         30         30           AIR AVE         10         1,146         0         1146         0         0         33         33           SOARING GAIL AVE         10         1,236         0         1236         0         0         35         35           FEATHERTAIL ST         10         1,804         2         1746         0         0         50         50           FEATHER FALL AVE         10         1,342         0         1342         0         0         38         38           PERCH VIEW DR         10         1,084         0         1084         0         0         31         31           GILDEWING AVE         10         1,504         2         1446         0         0         41         41           GILDEWING PL         10         316         0         316         0         0         9         9           HATCHLING CT         10         679         0         679         0         0         19         19           FLIGHT PATH AVE         10         356         0         356         0			-			ļ			
SOARING GAIL AVE         10         1,236         0         1236         0         0         35         35           FEATHERTAIL ST         10         1,804         2         1746         0         0         50         50           FEATHER FALL AVE         10         1,342         0         1342         0         0         38         38           PERCH VIEW DR         10         1,084         0         1084         0         0         31         31           GILDEWING AVE         10         1,504         2         1446         0         0         41         41           GILDEWING PL         10         316         0         316         0         0         9         9           HATCHLING CT         10         679         0         679         0         0         19         19           FLIGHT PATH AVE         10         356         0         356         0         0         10         10	SWIFTLIGHT ST	+	1,058	0	1058	0	0	30	30
FEATHERTAIL ST         10         1,804         2         1746         0         0         50         50           FEATHER FALL AVE         10         1,342         0         1342         0         0         38         38           PERCH VIEW DR         10         1,084         0         1084         0         0         31         31           GILDEWING AVE         10         1,504         2         1446         0         0         41         41           GILDEWING PL         10         316         0         316         0         0         9         9           HATCHLING CT         10         679         0         679         0         0         19         19           FLIGHT PATH AVE         10         356         0         356         0         0         10         10	SWIFTLIGHT ST AERIAL HEIGHTS AVE UPDRAFT AVE		1,146			_	+ -		
PERCH VIEW DR         10         1,084         0         1084         0         31         31           GILDEWING AVE         10         1,504         2         1446         0         0         41         41           GILDEWING PL         10         316         0         316         0         0         9         9           HATCHLING CT         10         679         0         679         0         0         19         19           FLIGHT PATH AVE         10         356         0         356         0         0         10         10	SWIFTLIGHT ST AERIAL HEIGHTS AVE UPDRAFT AVE AIR AVE	10	1,236				+ -	50	
GILDEWING AVE 10 1,504 2 1446 0 0 41 41  GILDEWING PL 10 316 0 316 0 0 9 9  HATCHLING CT 10 679 0 679 0 0 19 19  FLIGHT PATH AVE 10 356 0 356 0 0 10	SWIFTLIGHT ST AERIAL HEIGHTS AVE UPDRAFT AVE AIR AVE SOARING GAIL AVE FEATHERTAIL ST	10			1740				
HATCHLING CT         10         679         0         679         0         0         19         19           FLIGHT PATH AVE         10         356         0         356         0         0         10         10	SWIFTLIGHT ST AERIAL HEIGHTS AVE UPDRAFT AVE AIR AVE SOARING GAIL AVE FEATHER FALL AVE	10 10 10 10	1,804 1,342	2 0	1342		+ -		
FLIGHT PATH AVE 10 356 0 0 10 10	SWIFTLIGHT ST AERIAL HEIGHTS AVE UPDRAFT AVE AIR AVE SOARING GAIL AVE FEATHERTAIL ST FEATHER FALL AVE PERCH VIEW DR	10 10 10 10 10	1,804 1,342 1,084	2 0 0	1342 1084	0	0	31	31
TOTAL STREET TREES 940 907	SWIFTLIGHT ST AERIAL HEIGHTS AVE UPDRAFT AVE AIR AVE SOARING GAIL AVE FEATHERTAIL ST FEATHER FALL AVE PERCH VIEW DR GILDEWING AVE	10 10 10 10 10 10 10	1,804 1,342 1,084 1,504 316	2 0 0 2 0	1342 1084 1446 316	0 0	0 0	31 41 9	31 41 9
	SWIFTLIGHT ST AERIAL HEIGHTS AVE UPDRAFT AVE AIR AVE SOARING GAIL AVE FEATHERTAIL ST FEATHER FALL AVE PERCH VIEW DR GILDEWING AVE GILDEWING PL HATCHLING CT	10 10 10 10 10 10 10	1,804 1,342 1,084 1,504 316 679	2 0 0 2 0	1342 1084 1446 316 679	0 0 0	0 0 0	31 41 9 19	31 41 9 19

<sup>\*</sup> CLASS I TREES PROVIDED AT A 1:25' RATIO DUE TO OVER HEAD POWER. \*\* SHRUBS TO BE PROVIDED WITH INDIVIDUAL PHASING PLANS - SEE PLANTER BED HATCH WITH SUGGESTED PLANTINGS ON PPL9.0.



LANDSCAPE CONSULTANT KM ENGINEERING, LLP

5725 NORTH DISCOVERY WAY

CONTACT: ALYSSA YENSEN, PLA

EMAIL: ayensen@kmengllp.com


BOISE, IDAHO 83713


PHONE: (208) 639-6939

FAX: (208) 639-6930

DEVELOPER/OWNER BRIGHTON DEVELOPMENT INC. 2929 W. NAVIGATOR DR., SUITE 400 MERIDIAN, IDAHO 83642 PHONE: (208) 378-4000 CONTACT: JON WARDLE EMAIL: jwardle@brightoncorp.com



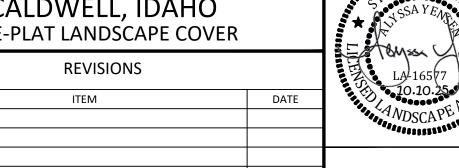

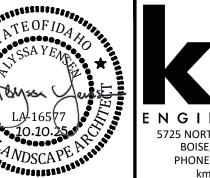


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PROJECT: SHEET NO.


NOTE: SHRUB COUNT EXCLUDES ALL PERENNIALS AND GRASSES. IF PERENNIALS AND GRASSES ARE SUBSTITUTED FOR THE REQUIRED SHRUBS, THEY MUST BE PLANTED AT A MIN. 2 GAL. SIZE

PLANT PALETTE SEE PPL9.0 FOR PLANT SCHEDULE

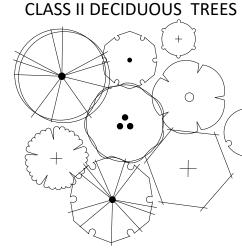


CRIMSON SENTRY MAPLE URBAN SUNSET MAPLE AUTUMN BLAZE MAPLE DURAHEAT RIVER BIRCH MULTI-TRUNK EMERALD AVANUE HORNBEAM PRINCETON SENCTRY GINKGO SUNBURST HONEYLOCUST COLUMNAR SWEET GUM GREEKSPIRE LITTLELEAF LINDEN

CLASS I DECIDUOUS TREES

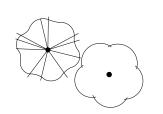


SPRING SNOW CRABAPPLE THUNDERCLOUD PRUPLE LEAF PLUM

#### **EVERGREEN TREES**

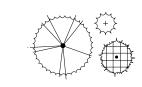

FUCHS DEODAR CEDAR BLACK HILLS SPRUCE HOOPSI BLUE SPRUCE

#### SHRUB BEDS SEE KEY NOTE #3 FOR GROUNDCOVER MATERIAL

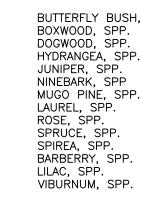

BLUE FESCUE, SPP. REED GRASS, SPP. FOUNTAIN GRASS, SPP. DIANTHUS, SPP. CONEFLOWER, SPP. DAYLILY, SPP. HOSTA, SPP. LAVENDER, SPP. BLACK-EYED SUSAN, SPP. PHLOX, SPP. SALVIA, SPP. SAGE, SPP.

MATERIAL LEGEND SEE PLANT SCHEDULE ON PPL9.0 FOR GENERAL SPECIFICATIONS

NO-MOW FESCUE


### KEY NOTES (TYPICAL) $\langle \# \rangle$

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- 4. TREES PLANTED IN PARK STRIPS TO BE CENTERED IN STRIP.
- 5. INSTALL FLAT-BLADE SHOVEL EDGING AT INTERFACE OF SOD AND PLANTER BED & PLANTER
- 6. OPEN VISION FENCE SEE PPL8.0 FOR FENCE PLAN.
- 7. CLOSED VISION FENCE SEE PPL8.0 FOR FENCE PLAN.
- 8. 3:1 LANDSCAPE BERM HEIGHT VARIES BETWEEN 2' 4'.
- 9. CLUBHOUSE & POOL LAYOUT IS SCHEMATIC AND SHOWN FOR ILLUSTRATIVE PURPOSES ONLY. FINAL LAYOUT TO BE APPROVED THROUGH SEPARATE SUBMITTAL.
- 10. TOT LOT WITH SEATING PLAY EQUIPMENT IS SHOWN FOR ILLUSTRATIVE PURPOSES ONLY.
  FINAL LAYOUT AND SPECIFICATIONS TO BE APPROVED AS A PART OF CORRESPONDING PHASE
- 11. BBQ STATION WITH SHADE STRUCTURE SHOWN FOR ILLUSTRATIVE PURPOSES ONLY. FINAL LAYOUT AND SPECIFICATIONS TO BE APPROVED AS A PART OF CORRESPONDING PHASE LANDSCAPE PLAN.
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	REVISIONS		7
	CALDWELL, IDAHO PRE-PLAT LANDSCAPE PLAN		Munte
1	AVIARY HEIGHTS SUBDIVISI	ION	

PHONE (208) 639-6939 kmengllp.com PROJECT: SHEET NO. PPL2.0


5725 NORTH DISCOVERY WAY BOISE, IDAHO 83713

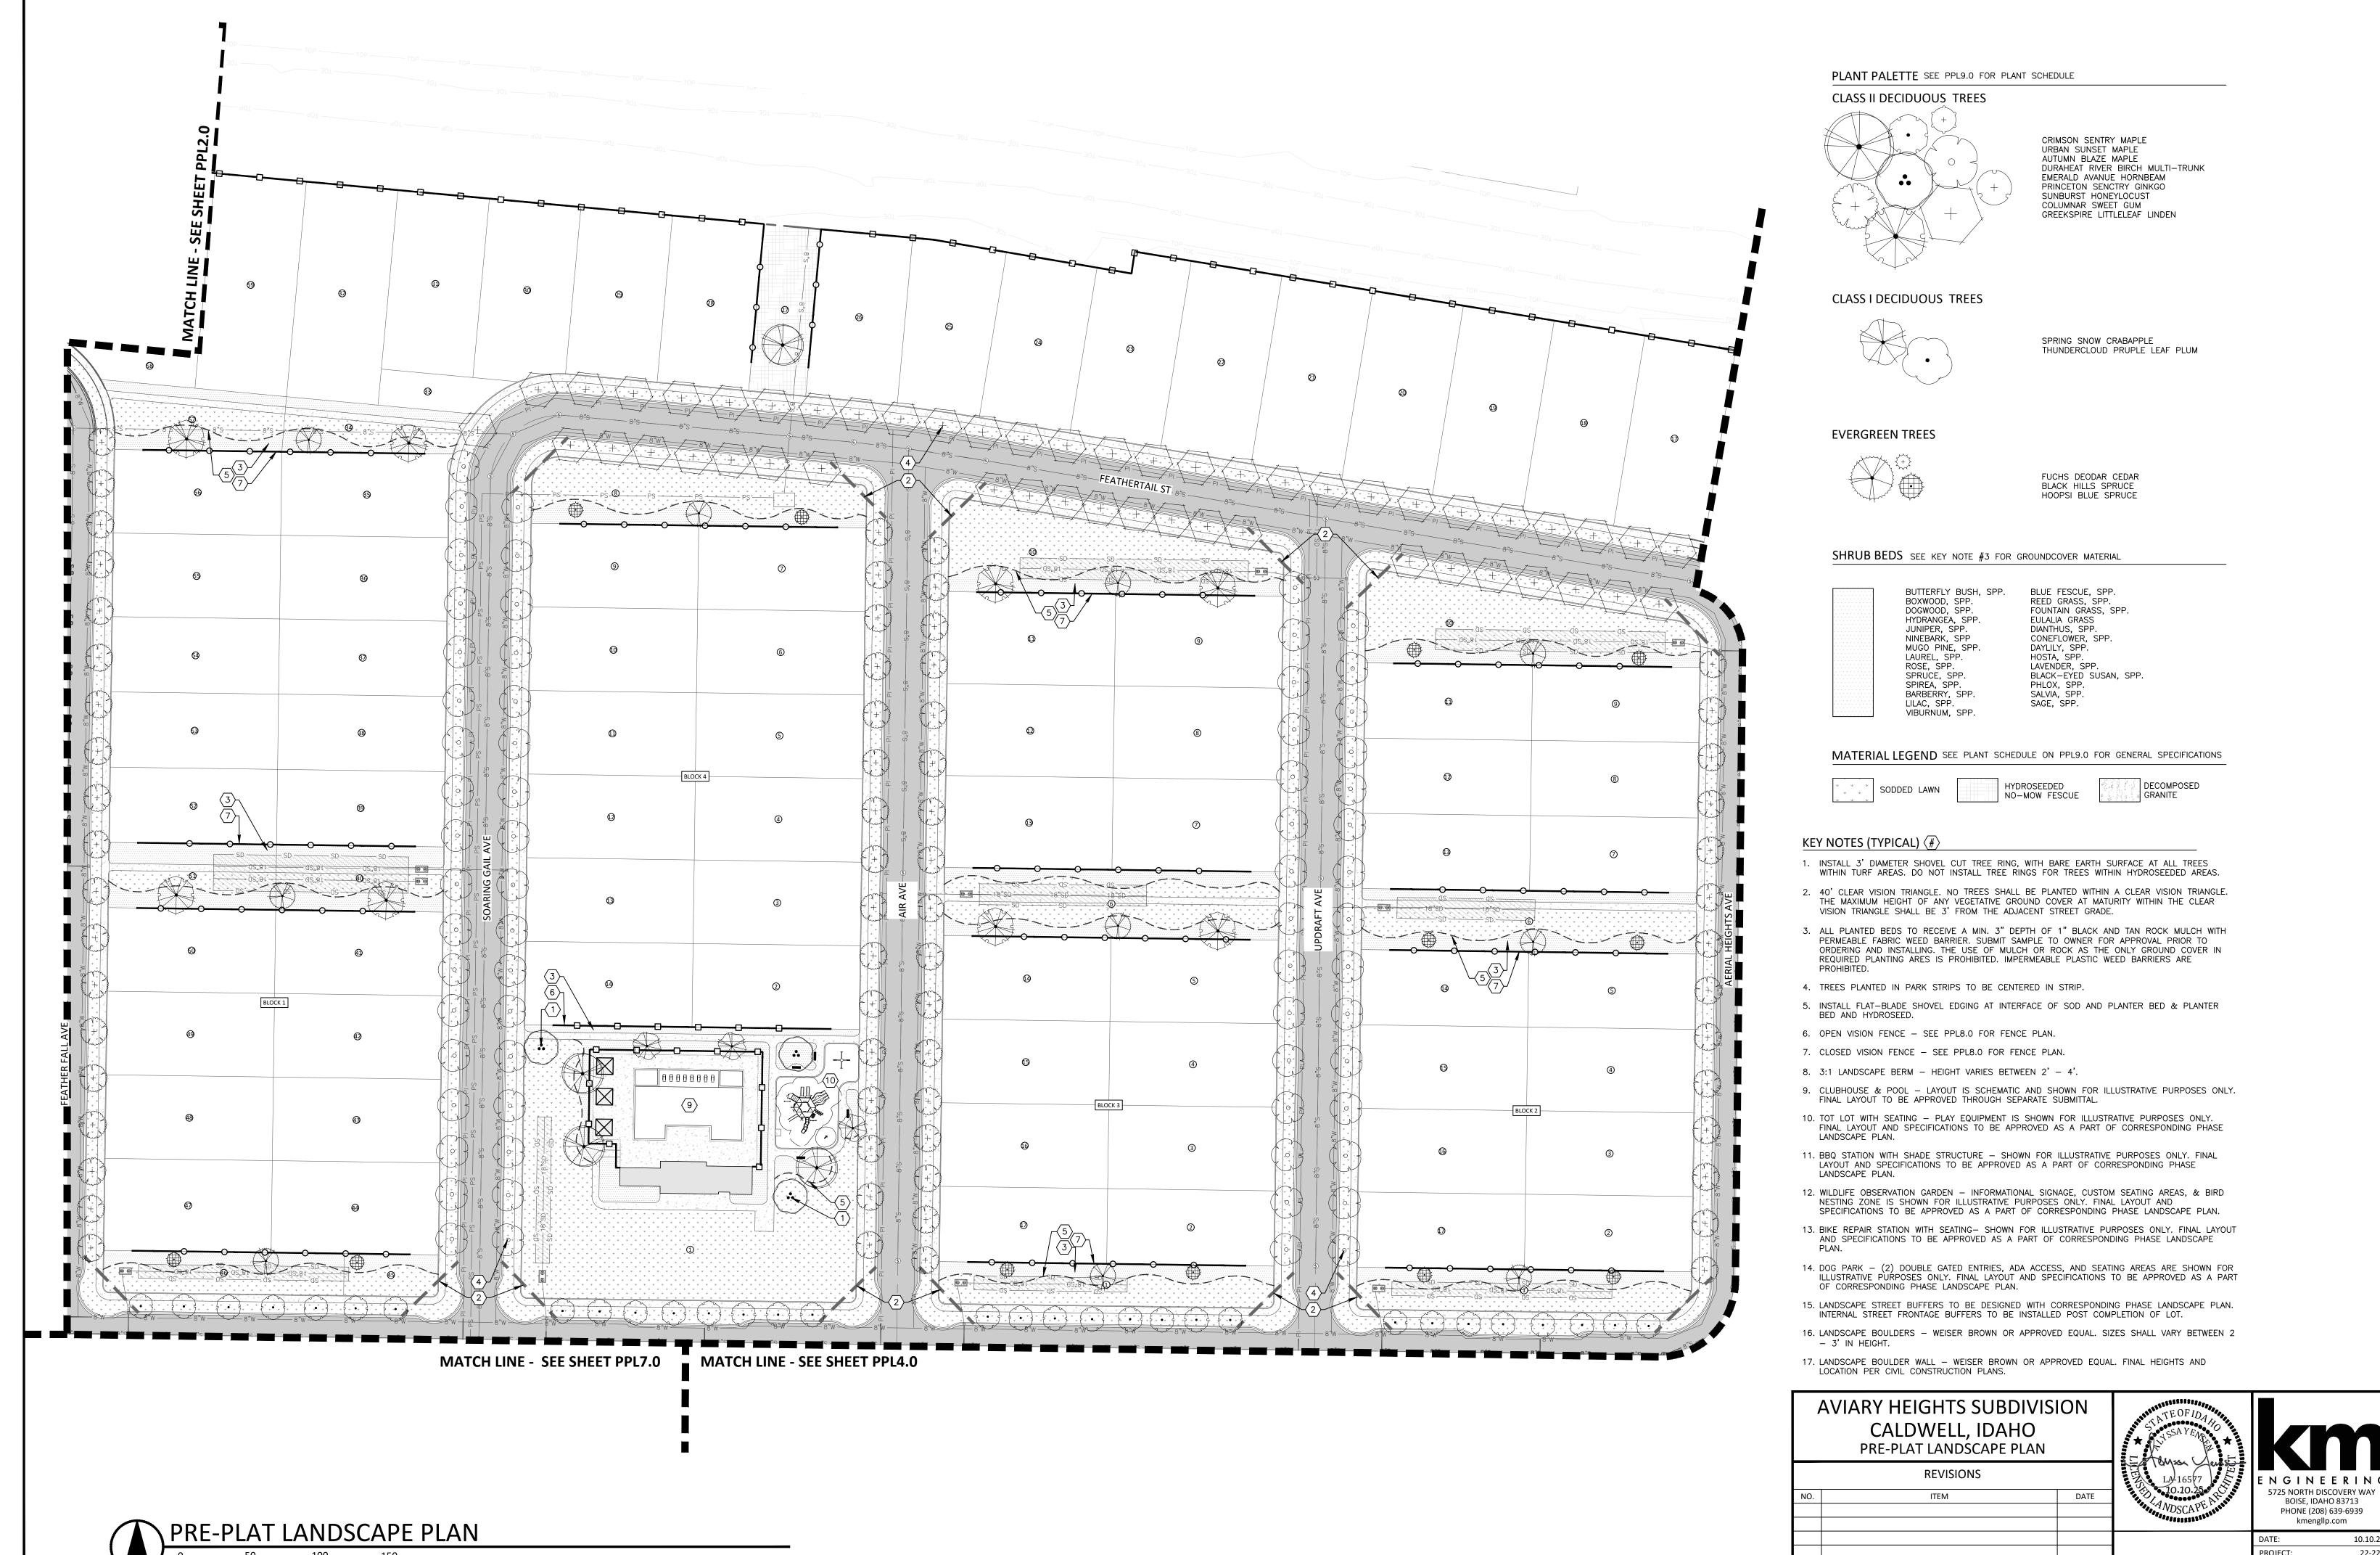

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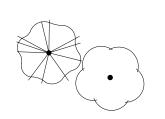
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PPL3.0

PLANT PALETTE SEE PPL9.0 FOR PLANT SCHEDULE

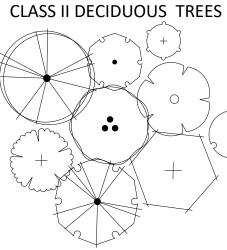


CRIMSON SENTRY MAPLE URBAN SUNSET MAPLE AUTUMN BLAZE MAPLE DURAHEAT RIVER BIRCH MULTI-TRUNK EMERALD AVANUE HORNBEAM PRINCETON SENCTRY GINKGO SUNBURST HONEYLOCUST COLUMNAR SWEET GUM GREEKSPIRE LITTLELEAF LINDEN

#### CLASS I DECIDUOUS TREES




SPRING SNOW CRABAPPLE THUNDERCLOUD PRUPLE LEAF PLUM

#### **EVERGREEN TREES**

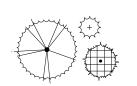

FUCHS DEODAR CEDAR BLACK HILLS SPRUCE HOOPSI BLUE SPRUCE

#### SHRUB BEDS SEE KEY NOTE #3 FOR GROUNDCOVER MATERIAL

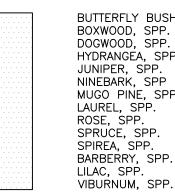

BOXWOOD, SPP. DOGWOOD, SPP. HYDRANGEA, SPP. JUNIPER, SPP. NINEBARK, SPP MUGO PINE, SPP. LAUREL, SPP. SPRUCE, SPP. SPIREA, SPP. BARBERRY, SPP. LILAC, SPP.

BLUE FESCUE, SPP. REED GRASS, SPP. FOUNTAIN GRASS, SPP. EULALIA GRASS DIANTHUS, SPP. CONEFLOWER, SPP. DAYLILY, SPP. HOSTA, SPP. LAVENDER, SPP. BLACK-EYED SUSAN, SPP. PHLOX, SPP. SALVIA, SPP. SAGE, SPP.


#### MATERIAL LEGEND SEE PLANT SCHEDULE ON PPL9.0 FOR GENERAL SPECIFICATIONS


HYDROSEEDED NO-MOW FESCUE

### KEY NOTES (TYPICAL) (#)

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### AVIARY HEIGHTS SUBDIVISION CALDWELL, IDAHO PRE-PLAT LANDSCAPE PLAN




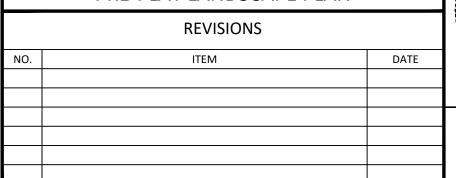
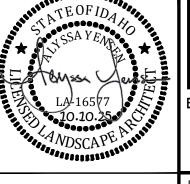
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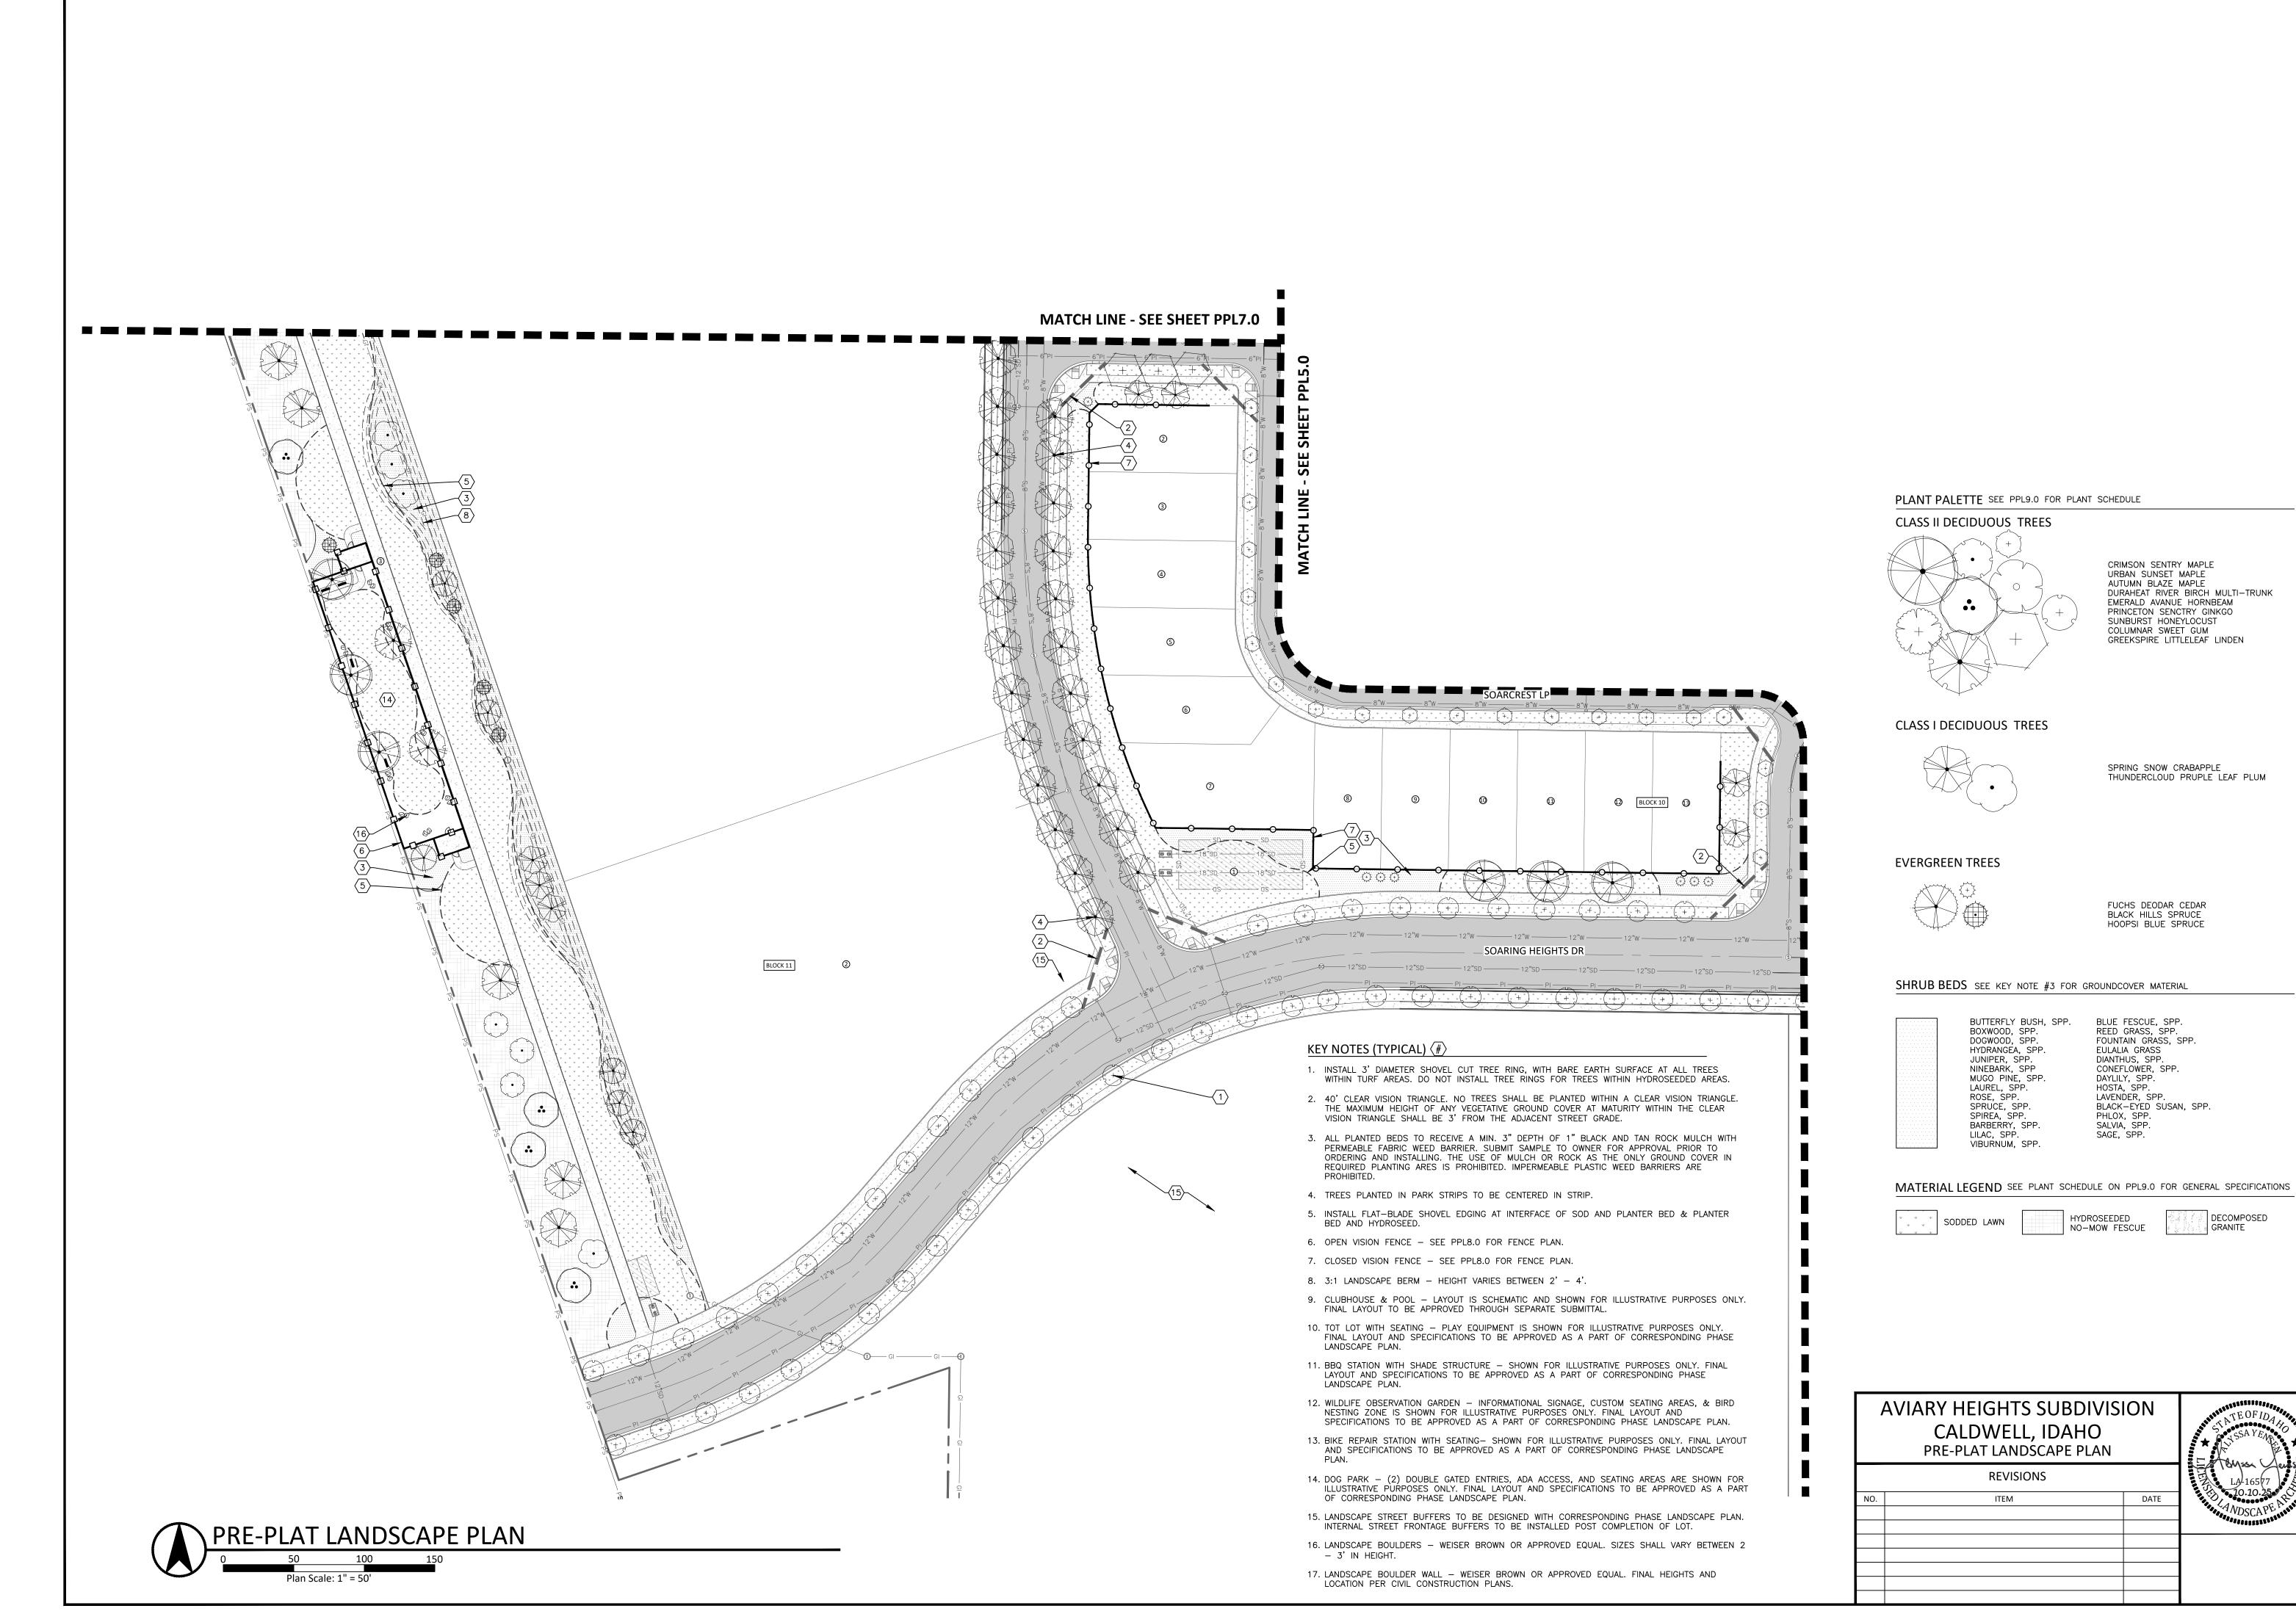
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SHEET NO. PPL4.0



PHONE (208) 639-6939 kmengllp.com SHEET NO.

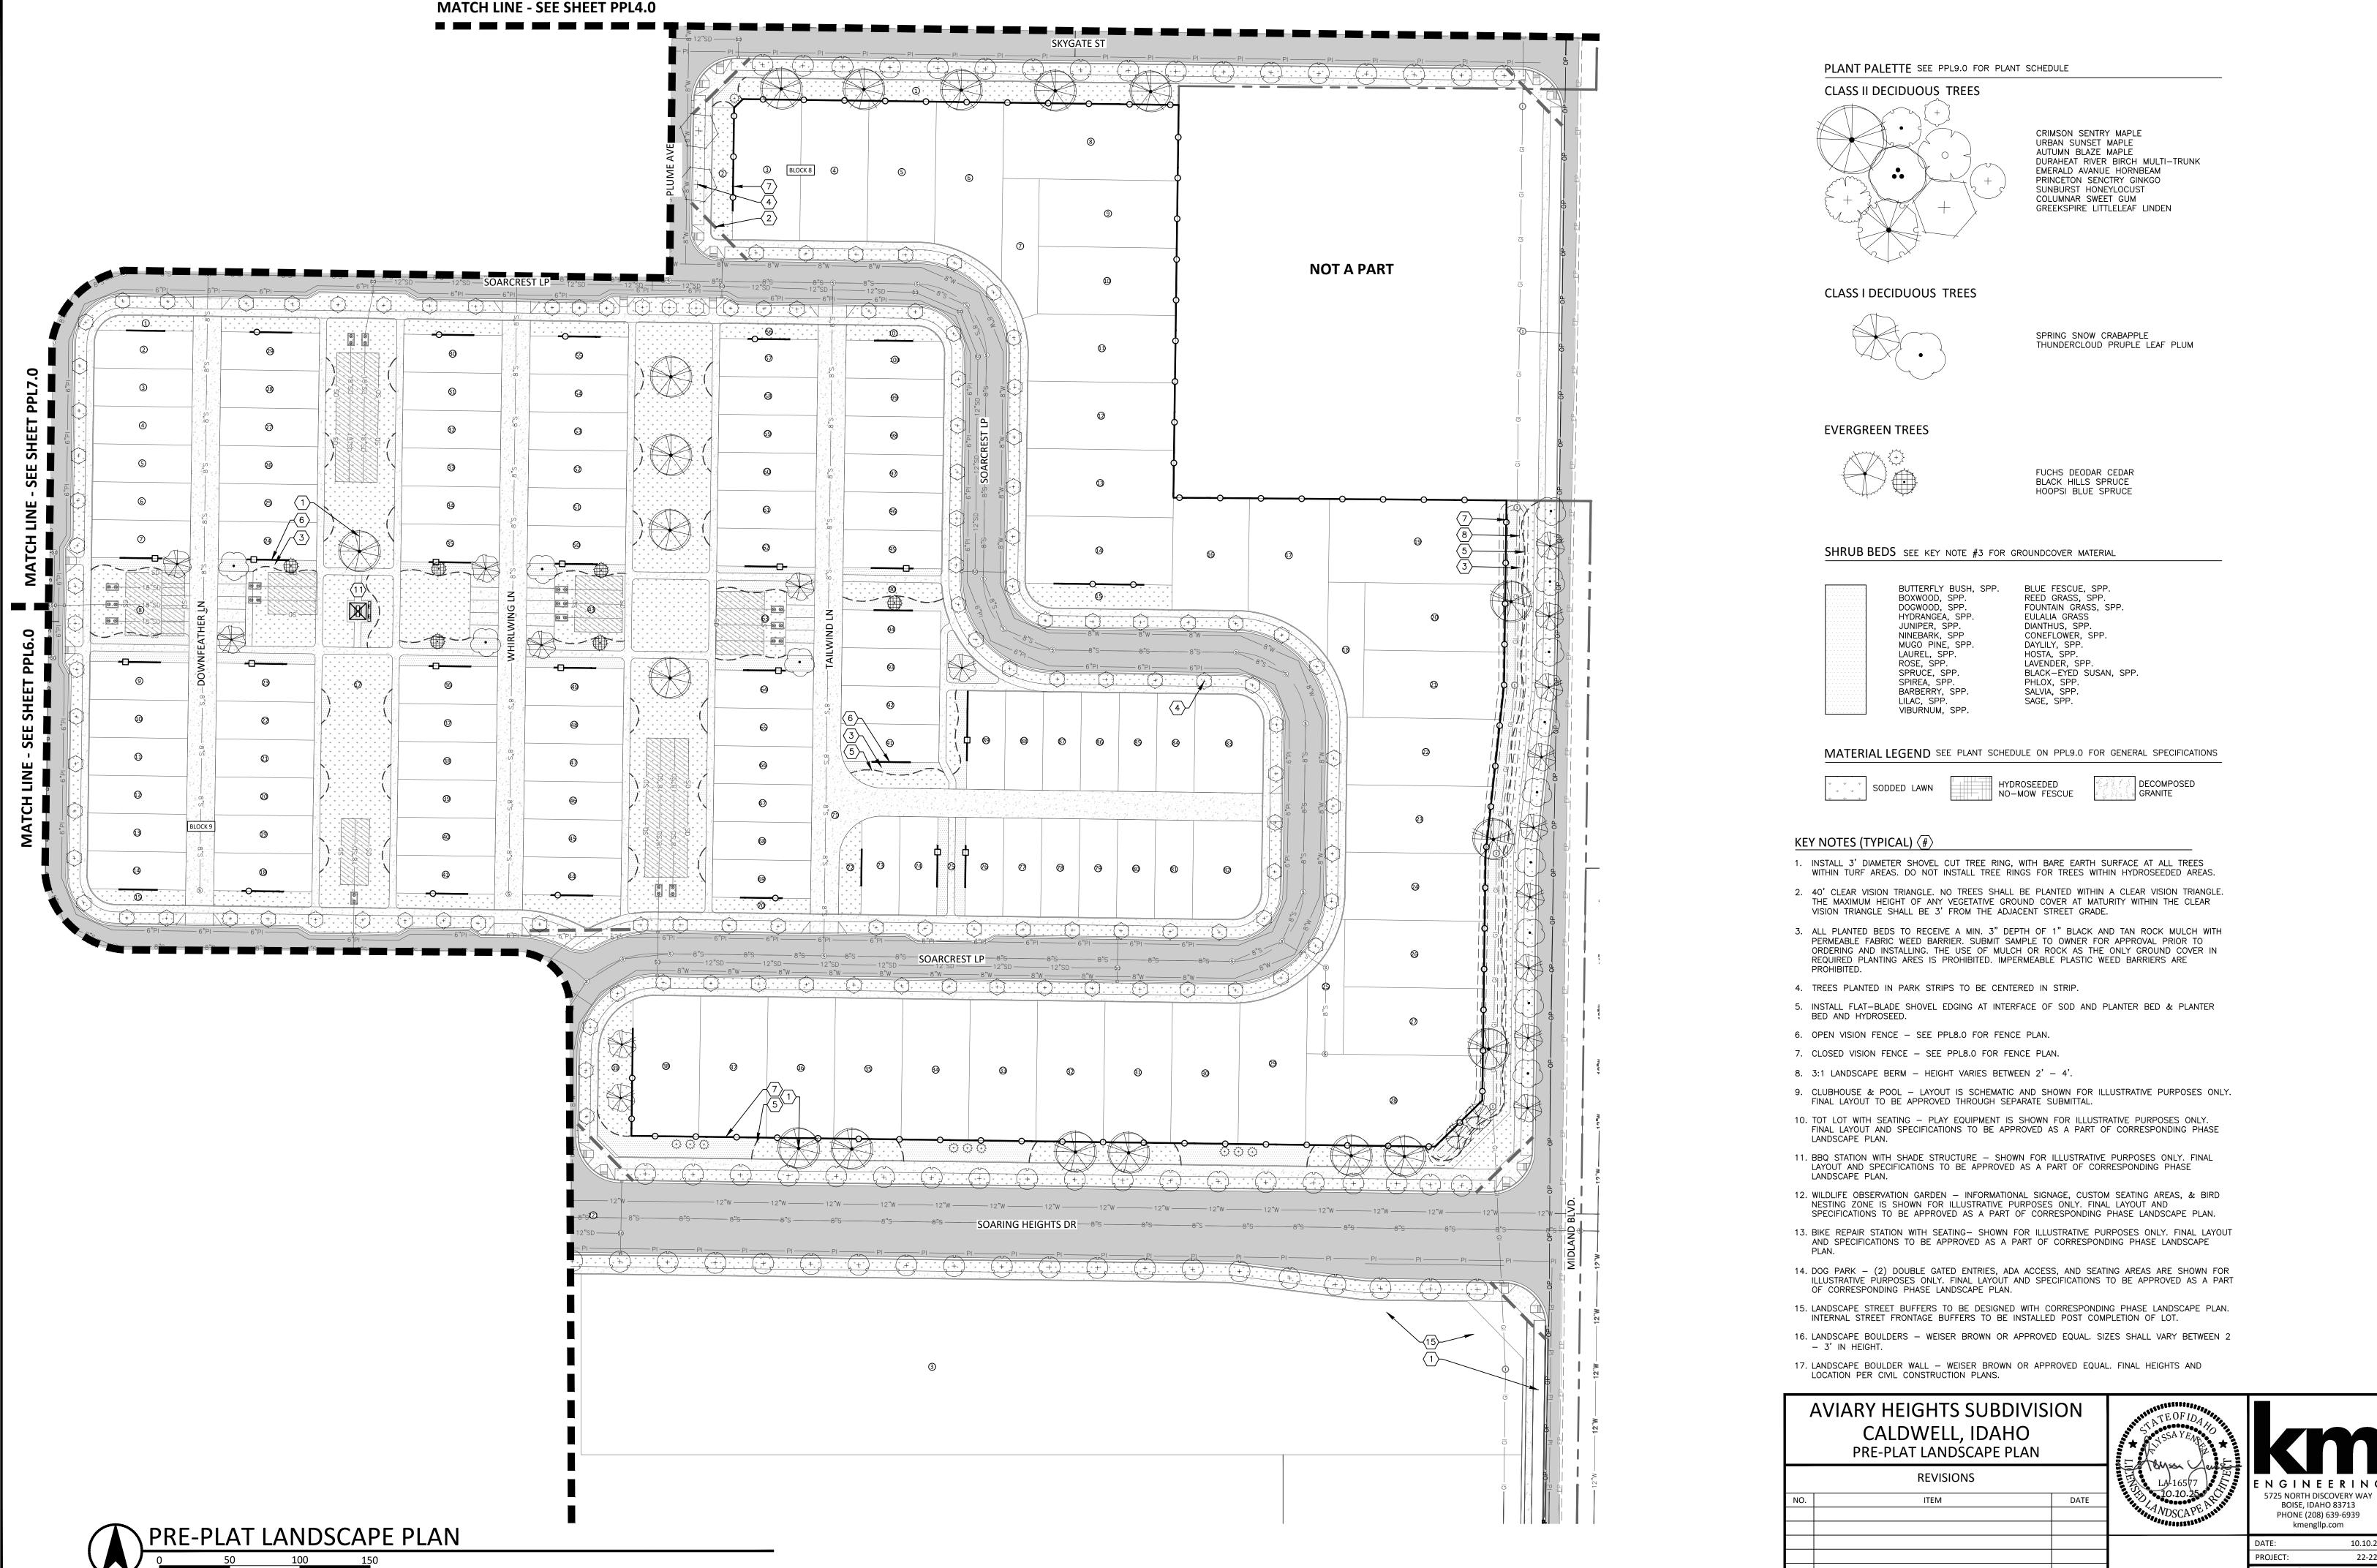PPL5.0





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BOISE, IDAHO 83713 PHONE (208) 639-6939

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PPL8.0

10.10.25

O2 SOARING HEIGHTS DR. BUFFER SECTION NTS

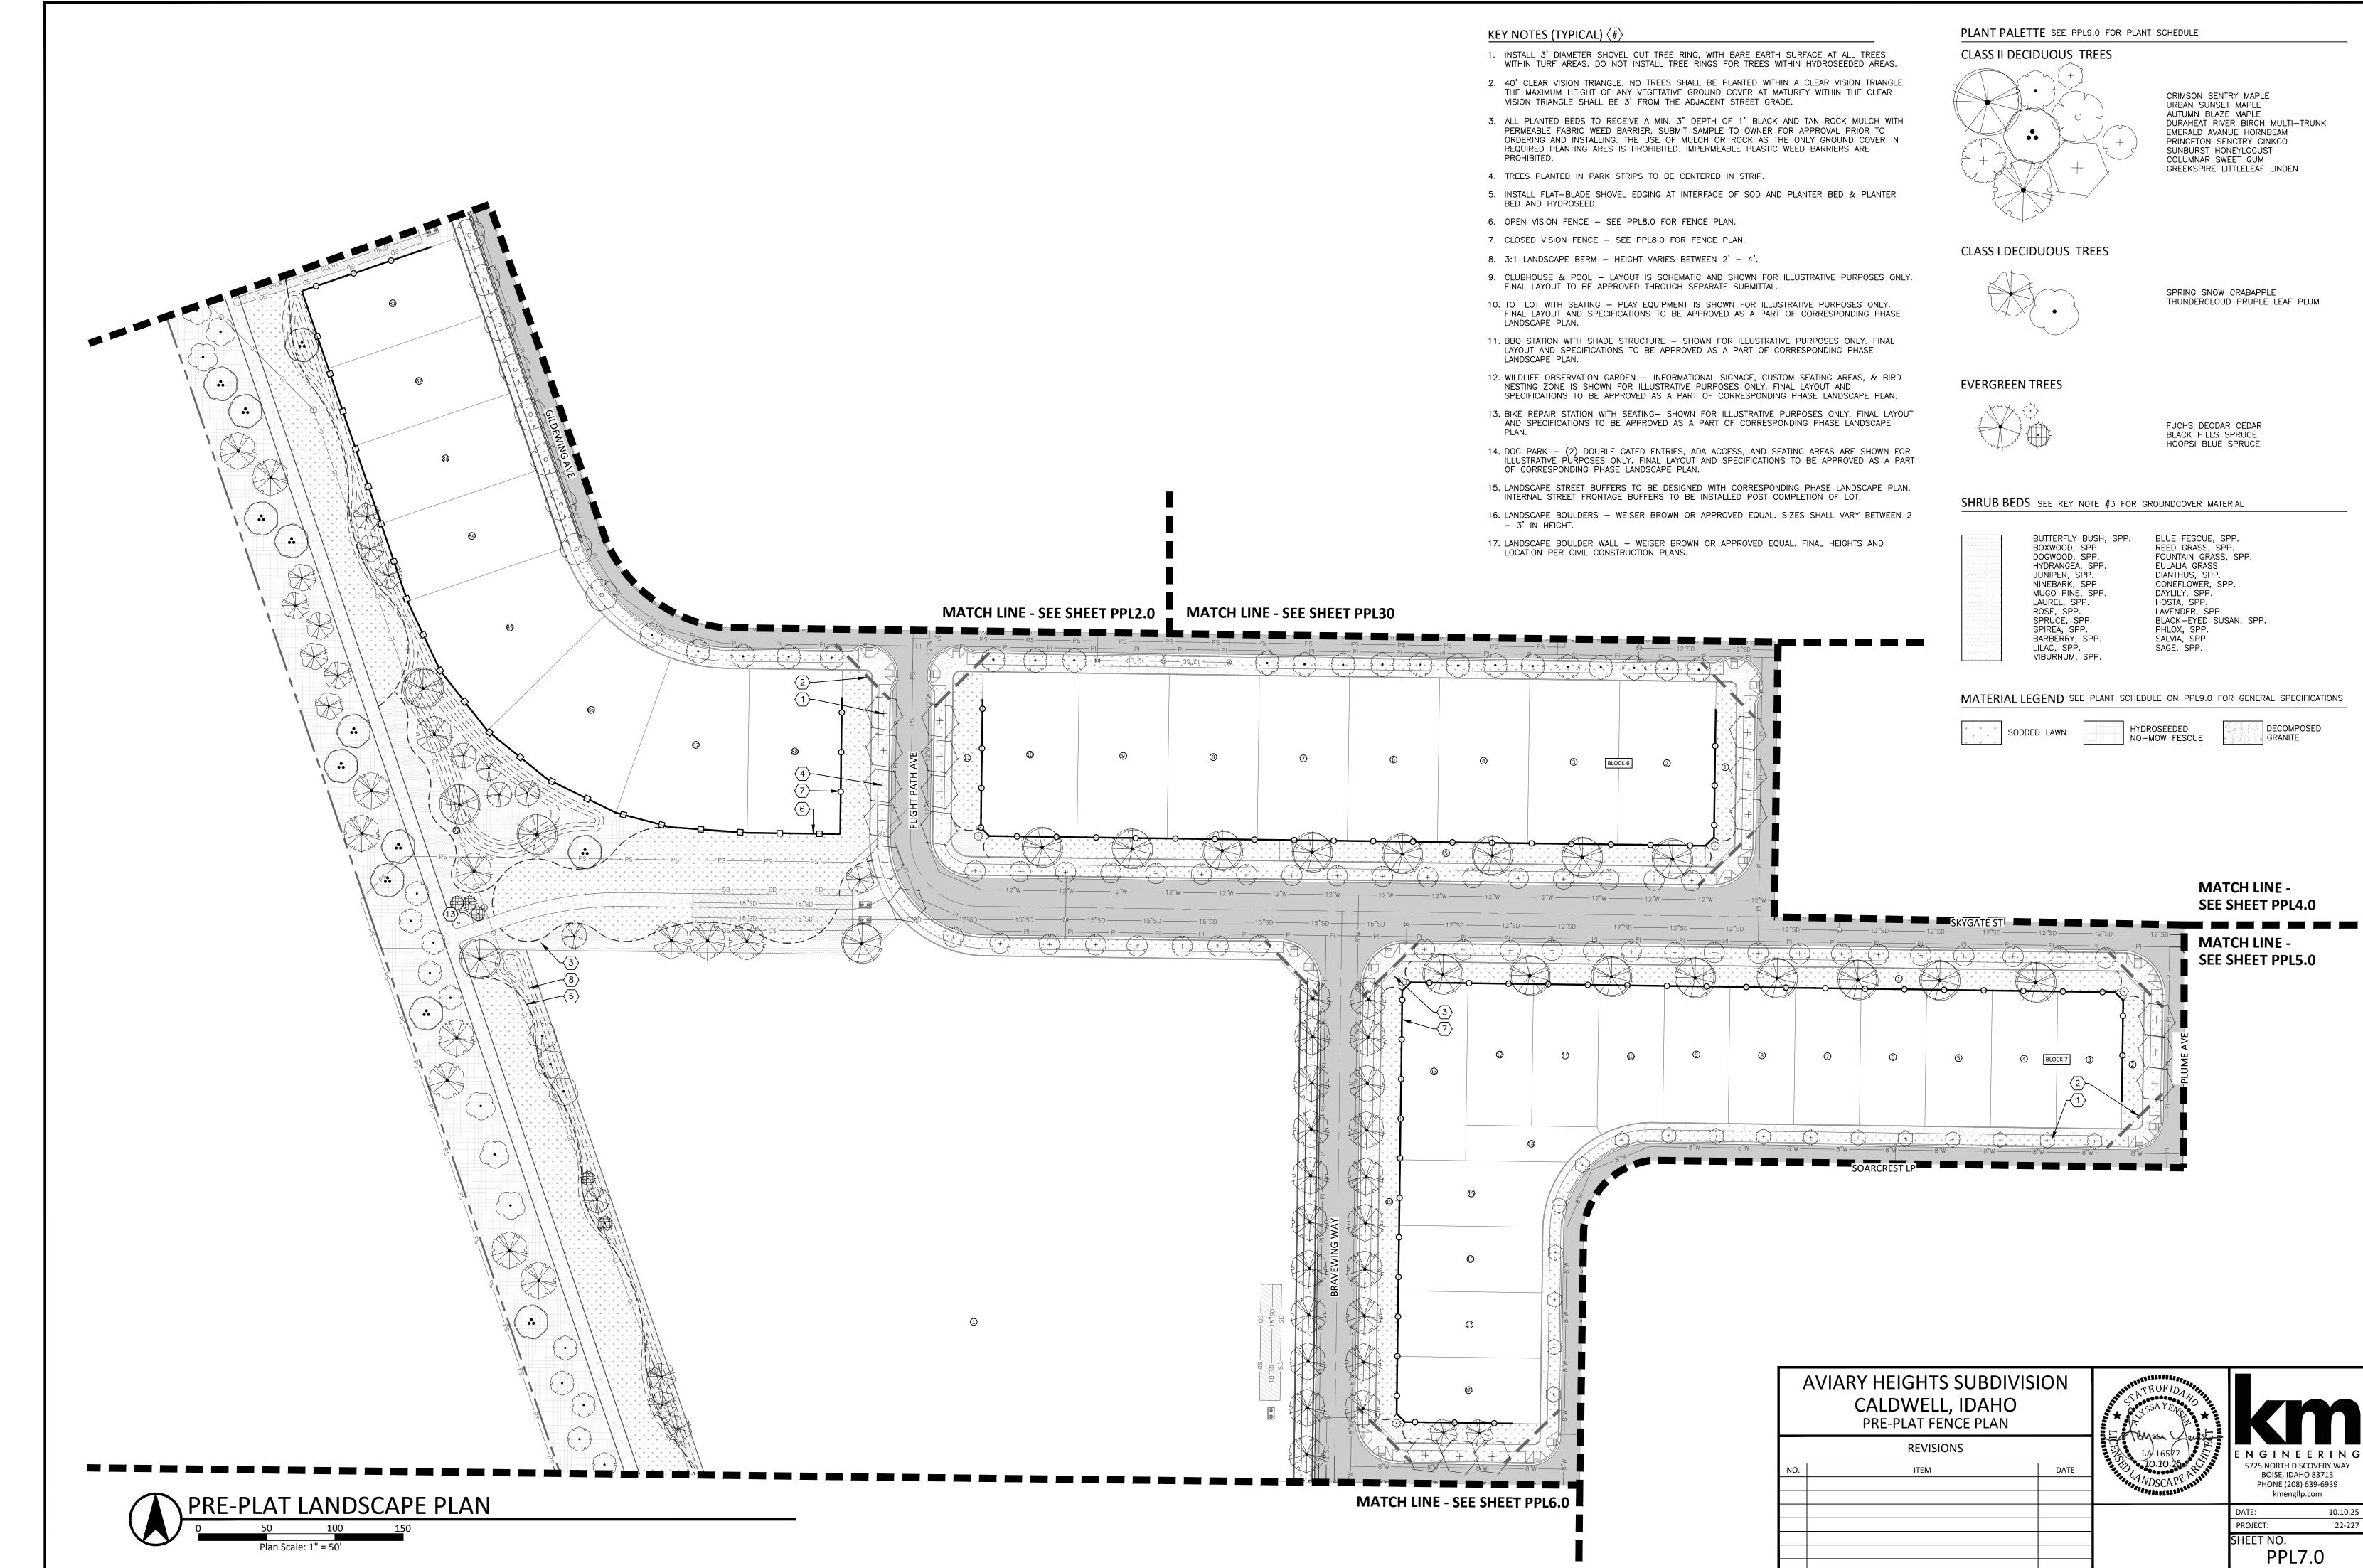FINAL LAYOUT AND SPECIFICATIONS TO BE APPROVED AS A PART OF CORRESPONDING PHASE LANDSCAPE PLAN.

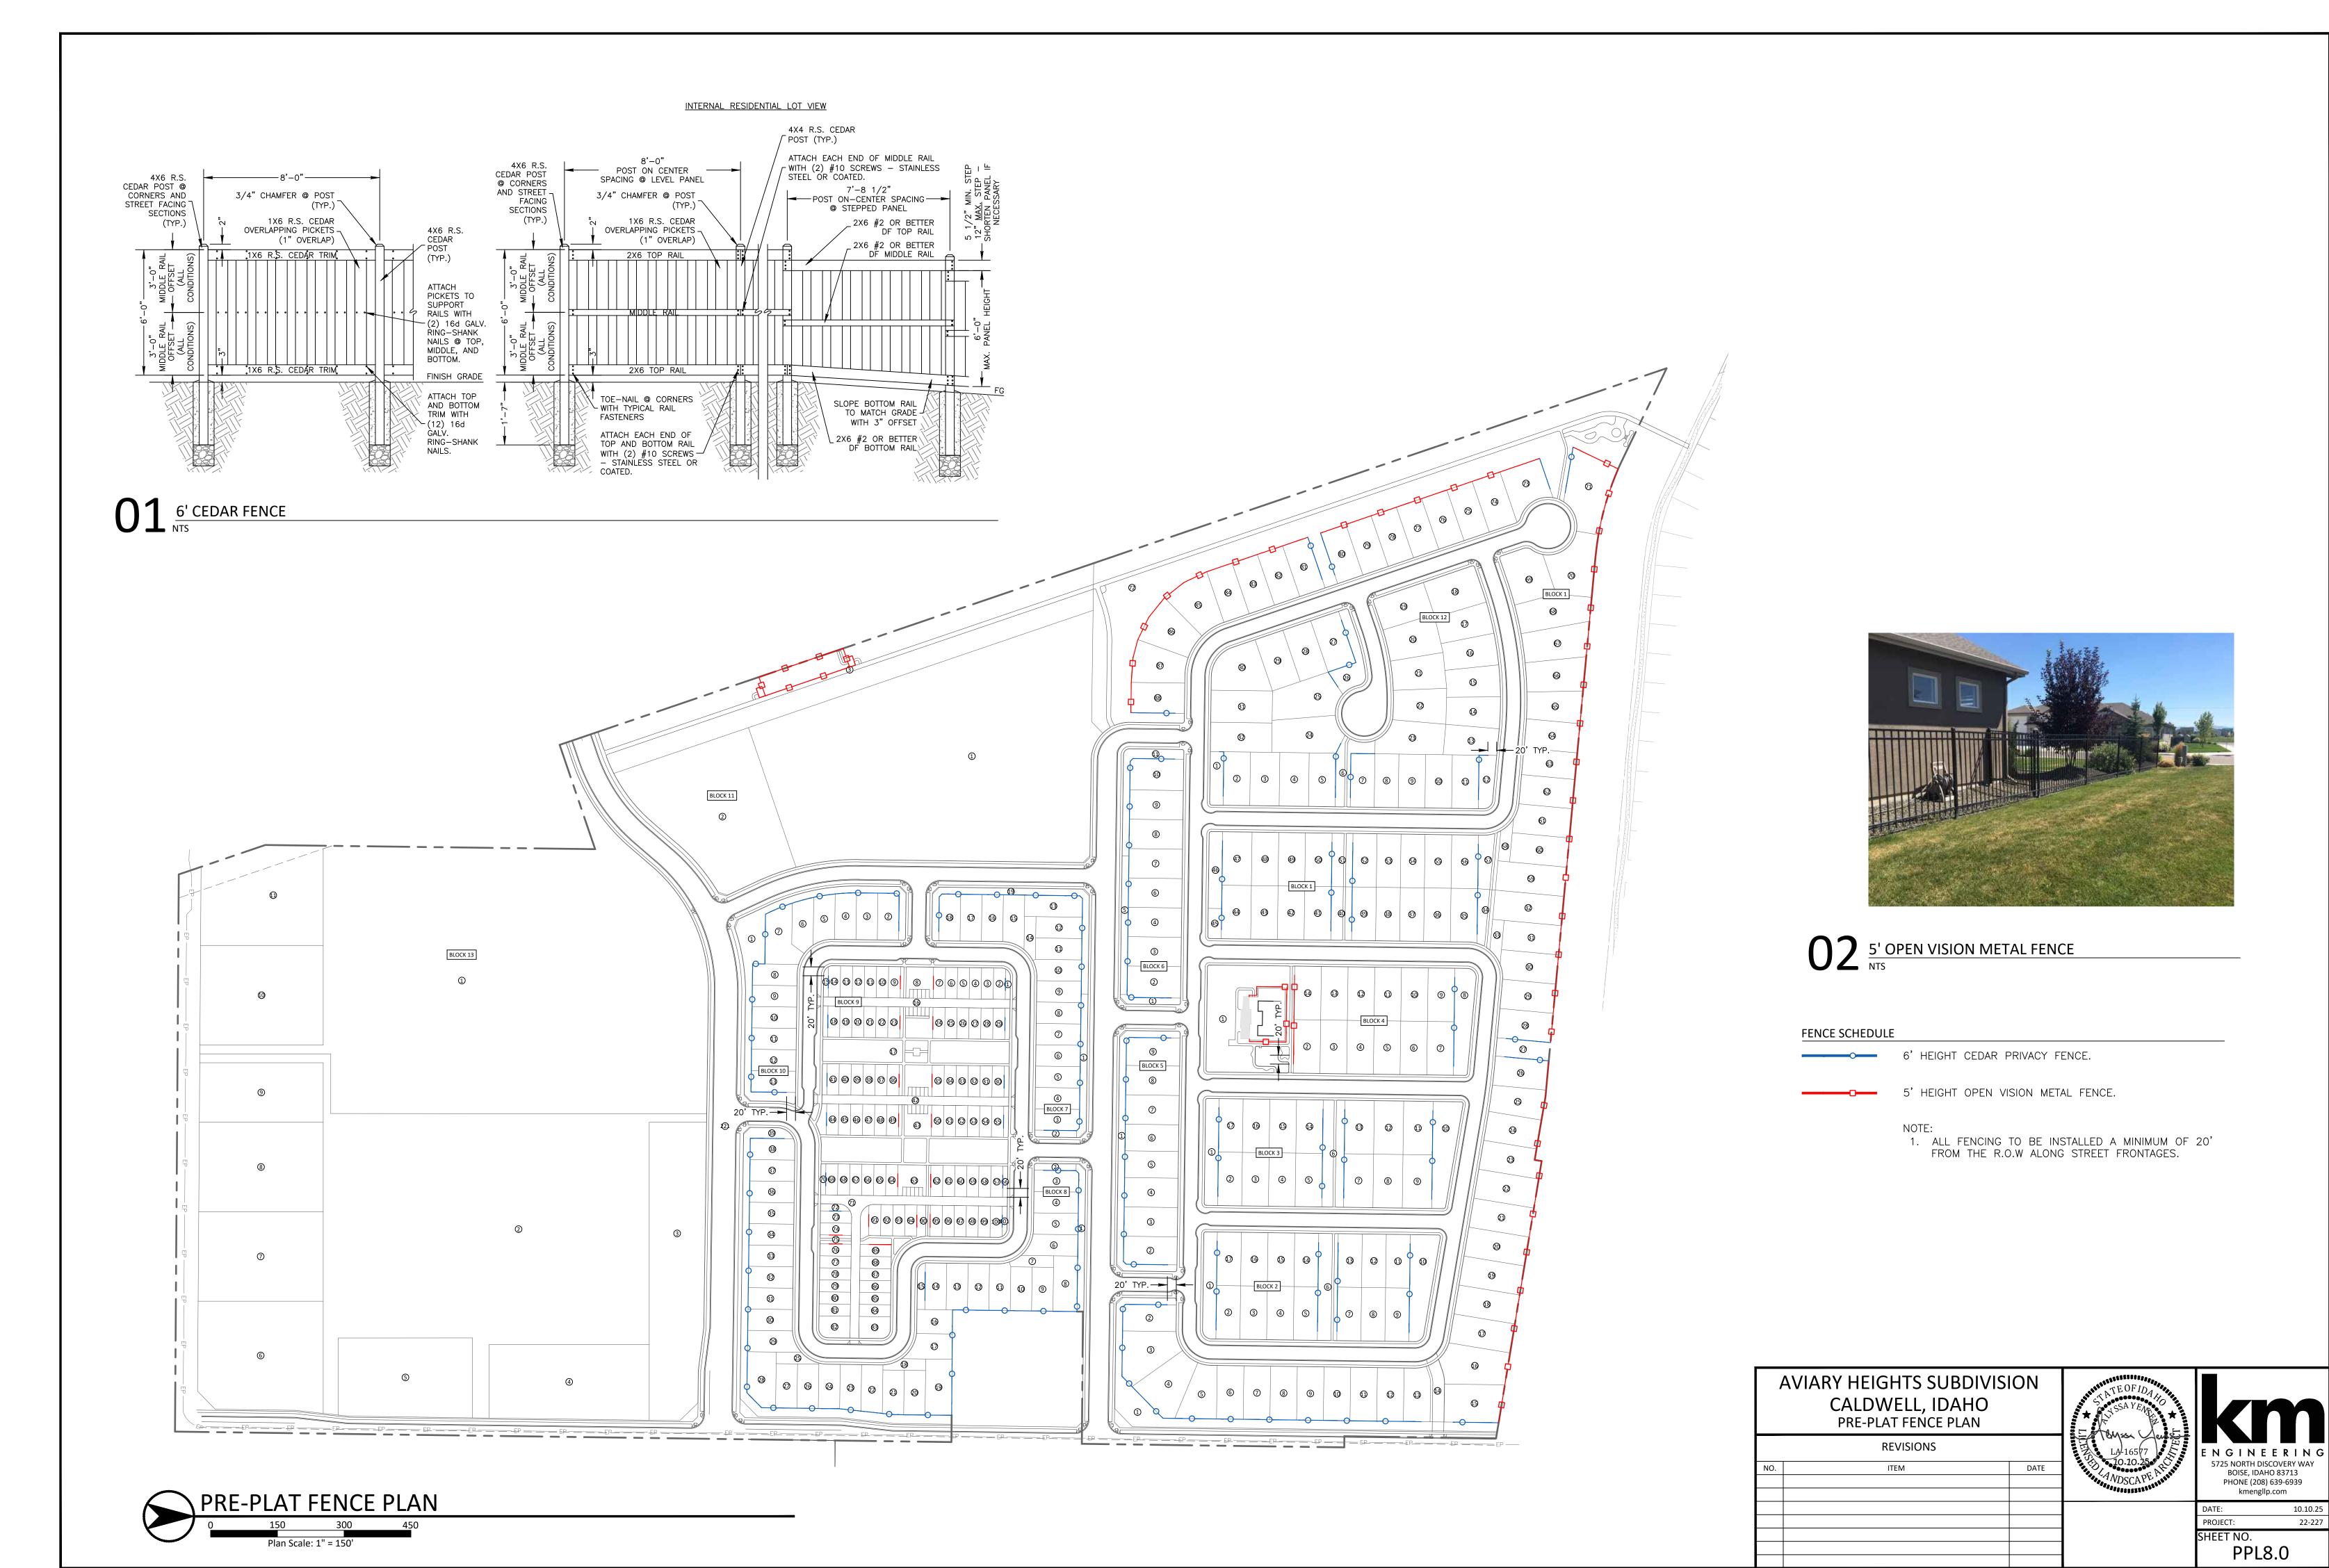SOARING HEIGHTS DR. LAWN SOARING HEIGHTS DR. LAWN SOARING HEIGHTS DR. LAWN WALKWAY 15' LANDSCAPE BUFFER-

1. LANDSCAPING IS SCHEMATIC —
FINAL LAYOUT AND SPECIFICATIONS TO BE APPROVED AS A PART OF CORRESPONDING PHASE LANDSCAPE PLAN.

MIDLAND BLVD BERM BUFFER SECTION

1. LANDSCAPING IS SCHEMATIC -

–20' LANDSCAPE BUFFER –

PLANT SCHEDULE

SYMBOL	QTY	BOTANICAL / COMMON NAME	SIZE	MATURE HXW	CLASS
DECIDUOUS	S TREES				
+	173	ACER PLATANOIDES 'CRIMSON SENTRY' CRIMSON SENTRY MAPLE	2" CAL. B&B	25'X15'	CLASS II
	107	ACER TRUNCATUM X PLATANOIDES 'JFS-KW187' URBAN SUNSET® MAPLE	2" CAL. B&B	35'X2Ø'	CLASS II
	67	ACER X FREEMANII 'JEFFSRED' AUTUMN BLAZE MAPLE	2" CAL. B&B	50°X30°	CLASS II
	36	BETULA NIGRA 'DURAHEAT' DURAHEAT RIVER BIRCH MULI-TRUNK	2" CAL. B&B CLUMP	35'X3Ø'	CLASS II
+	133	CARPINUS BETULUS 'JFS-KW1CB' EMERALD AVENUE HORNBEAM	2" CAL. B&B	40'X30'	CLASS II
£+3	1Ø1	GINKGO BILOBA 'PNI 272Ø' PRINCETON SENTRY® GINKGO MALE VARIETY ONLY	2" CAL. B&B	45'X2Ø'	CLASS II
	115	GLEDITSIA TRIACANTHOS INERMIS 'SUNCOLE' SUNBURST HONEYLOCUST	2" CAL. B&B	4Ø'X25'	CLASS II
+	153	LIQUIDAMBAR STYRACIFLUA 'SLENDER SILHOUETTE' COLUMNAR SWEET GUM	2" CAL. B&B	25'X15'	CLASS II
	45	MALUS "SPRING SNOW" SPRING SNOW CRABAPPLE	2" CAL. B&B	25'X2Ø'	CLASS I
	67	PRUNUS CERASIFERA 'THUNDERCLOUD' THUNDERCLOUD PURPLE LEAF PLUM	2" CAL. B&B	20'X20'	CLASS I
	86	TILIA CORDATA 'GREENSPIRE' GREENSPIRE LITTLELEAF LINDEN	2" CAL. B&B	45'X35'	CLASS II
EVERGREEN	N TREES				
++	25	CEDRUS DEODARA 'KARL FUCHS' FUCHS DEODAR CEDAR	6'-8' B&B	15'X8'	EVERGREEN
	34	PICEA GLAUCA 'DENSATA' BLACK HILLS WHITE SPRUCE	6'-8' B&B	55'X25'	EVERGREEN
	39	PICEA PUNGENS 'HOOPSII' HOOPSI BLUE SPRUCE	6'-8' B&B	35'X15'	EVERGREEN
SYMBOL	<u>QTY</u>	BOTANICAL / COMMON NAME	CONT		
SOD/SEED	147,77Ø SF	NO MOW LAWN SEED MIX HIGH COUNTRY GARDENS, PRAIRIE NURSERY OR APPROVED EQUAL SPECIALLY BLENDED MIX OF (6) DIFFERENT DWARF FINE FESCUE GRASS VARIETIES INSTALL AT MIN. OF 5 LBS PER 1000 SQUARE FEET	SEED		
\(\psi\) \(\	574,187 SF	TURF SOD RHIZOMATOUS RHIZOMATOUS TALL FESCUE	SOD		
<u>OTHER</u>	4,190 SF	DECOMPOSED GRANITE TBD	- MIN. 2-GAL SHRUBS		
	136,981 SF	SHRUB BEDS	OR 10" HEIGHT		
NOTE:		SEE PLANT PALETTE FOR SUGGESTED SHRUB VARIETIES	AND/OR SPREAD		
1. SPECI	FICATIONS ARE	SUBJECT TO CHANGE.			

### GENERAL LANDSCAPE NOTES

- 1. CONTRACTOR SHALL LOCATE AND IDENTIFY EXISTING UNDERGROUND AND OVERHEAD UTILITIES WITHIN CONTRACT WORK AREAS PRIOR TO CONSTRUCTION. CONTACT DIG LINE, INC. @ 1.800.342.1585. PROVIDE ADEQUATE MEANS OF PROTECTION OF UTILITIES AND SERVICES DESIGNATED TO REMAIN. REPAIR UTILITIES DAMAGED DURING SITE WORK OPERATIONS AT CONTRACTOR'S EXPENSE.
- 2. ALL PLANT MATERIAL SHALL CONFORM TO THE AMERICAN NURSERYMAN STANDARDS FOR TYPE AND SIZE SHOWN.
- 3. ALL TREE, TURF, PLANT MATERIAL, AND IRRIGATION PROPOSED WITHIN THE PLANTER STRIP BETWEEN BACK OF CURB AND SIDEWALK SHALL BE INSTALLED BY THE HOME BUILDER IN CONJUNCTION WITH THE INDIVIDUAL LOT DEVELOPMENT.
- 4. ALL TREES PLANTED IN THE PARK STRIP (BY BUILDER) TO BE CENTERED BETWEEN BACK OF CURB AND SIDEWALK AND ARE SUBJECT TO THE ACHD DEVELOPMENT AGREEMENT FOR LANDSCAPING.
- 5. FENCING WITHIN SUBDIVISION, ALONG SIDE AND REAR LOT LINES SHALL BE INSTALLED BY BUILDER/HOMEOWNER IN CONJUNCTION WITH INDIVIDUAL LOT DEVELOPMENT AND SHALL COMPLY WITH THE STANDARDS ESTABLISHED IN THE SUBDIVISION'S CC&RS.

### GENERAL IRRIGATION NOTES

- 1. ALL PLANT MATERIALS TO BE WATERED BY THE DEVELOPMENT OR SUBDIVISION PRESSURIZED IRRIGATION SYSTEM. IRRIGATION OF COMMON AREAS SHALL BE VIA THE SUBDIVISION'S PRESSURIZED IRRIGATION SYSTEM. IRRIGATION OF INDIVIDUAL LOTS AND LANDSCAPING ALONG THE FRONTAGE OF PRIVATE LOTS SHALL BE PRESSURIZED IRRIGATION WATER, AND THE RESPONSIBILITY OF THE INDIVIDUAL LOT OWNERS.
- 2. COVERAGE; THE IRRIGATION SYSTEM SHALL BE DESIGNED TO PROVIDE ONE HUNDRED PERCENT (100%) COVERAGE WITH HEAD TO HEAD SPACING OR TRIANGULAR SPACING AS APPROPRIATÉ.
- 3. MATCHED PRECIPITATION RATES: SPRINKLER HEADS SHALL HAVE MATCHED PRECIPITATION RATES WITHIN EACH CONTROL VALVE.
- 4. IRRIGATION DISTRICTS: SPRINKLER HEADS IRRIGATING LAWN OR OTHER HIGH WATER DEMAND AREAS SHALL BE CIRCUITED SO THAT THEY ARE ON THE SEPARATE ZONE OR DISTRICT FROM THOSE IRRIGATING TREES, SHRUBS, OR OTHER REDUCED WATER DEMAND AREAS.
- 5. OVERSPRAY: SPRINKLER HEADS SHALL BE ADJUSTED TO REDUCE OVERSPRAY ONTO IMPERVIOUS SURFACES SUCH AS STREETS, SIDEWALKS, DRIVEWAYS, AND PARKING

AVIARY HEIGHTS SUBDIVISI CALDWELL, IDAHO PRE-PLAT NOTES & DETAILS	SSAYEAR S	kı	<u> </u>	
REVISIONS		LA 16577	ENGINE	ERING
ITEM	DATE	10.10.25 RECTAIN	5725 NORTH DISI BOISE, IDAH PHONE (208) kmenglip	O 83713 639-6939
			DATE:	10.10.25
			PROJECT:	22-227

SOARING HEIGHTS DR 15 3,236 2 3178 454 0 91 91 SKYGATE ST 15 2,992 4 2876 0 0 82 82 FEATHER CREST ST 10 194 0 194 0 0 6 6 8 BRAVEWING WAY 10 1,606 1 1577 0 0 45 45 PLUME AVE 10 188 0 188 0 0 5 5 5 SOARCREST LP 10 5,466 3 5379 0 0 154 154 EAGLE WING AVE 10 202 0 202 0 0 6 6 8 SKYRUN AVE 10 202 0 202 0 0 6 6 8 SKYRUN AVE 10 3,140 7 2937 0 0 84 84 AERIAL HEIGHTS AVE 10 1,036 0 1036 0 0 30 30 UPDRAFT AVE 10 1,058 0 1058 0 0 30 30 AIR AVE 10 1,146 0 1146 0 0 35 35 FEATHER TAIL ST 10 1,804 2 1746 0 0 50 50 FEATHER FALL AVE 10 1,084 0 1084 0 0 31 31 31 PERCH VIEW DR 10 1,084 0 1084 0 0 31 31	BLOCK #	LOT #			SQ.FT.			REQ	EES PRVD
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1	1	34			4431			1	1
									· ·
									<b>-</b>
2	1	57			5525			1	1
2									
2									
3	3							1	3
Fig.									
6									
6	5	1			12004			2	1
77								-	
7   19   1468	-								
B	7	2			1456			0	0
B									
B									
9	8	39			23130			5	19
9	-								
9   43   3544   3544   7   8   9   9   9   9   9   9   9   9   9									
9   63   70   745   0   0   0   0   9   9   72   9   940   0   0   0   0   0   9   9   72   9   940   0   0   0   0   0   0   9   9   9	9	43			34341			7	8
9 9 72 899								_	
9									
9   101   702   10   0   1   1   20499   1   1   1   1   1   3   115848   23   31   11   1   3   115848   1   3   1   3   1   1   3   1   1   3   1   1	9	75			1400			0	0
11 3 19988	9	101			702			0	0
12						_	_		
12			-				-	· ·	
TOTAL COMMON LOT TREES	12	12			4108			1	1
### PATHWAY CALCULATIONS  ### BLOCK # LOT # LOT # LF REQ PRVD REQ PRVD  1			FFC		6142			·	
	5' MICRO PATHWAY ((15	) SHRUB/100 LF)				1	1 -		
1	"					REQ	PRVD	REQ	PRVD
1									
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9 17 1065 150 0 0 0 0 0 9 63 63 69 10 0 0 0 1 1 9 75 70 10 0 0 0 1 1 9 75 70 10 0 0 0 1 1 9 9 90 215 32 0 0 0 1 1 1 1 1 1 1 1 1 1 1 1 1 1 1 1							+ -		· ·
9 63 69 10 0 0 1 9 75 70 10 0 0 0 1 7TOTAL PATHWAY TREES  STREET CALCULATIONS  10' LOCAL LANDSCAPE BUFFER: (1) CLASS II TREE / 35 LF OR (1) CLASS I / 25 LF 20' COLLECTOR LANDSCAPE BUFFER: (1) TREE / 35 LF OR (1) CLASS I / 25 LF; (1) SHRUB / 7 LF; 3:1  20' COLLECTOR LANDSCAPE BUFFER: (1) TREE / 35 LF OR (1) CLASS I / 25 LF; (1) SHRUB / 7 LF; 3:1  21' MINDE AREFIRL LANDSCAPE BUFFER: (1) TREE / 35 LF OR (1) CLASS I / 25 LF; (1) SHRUB / 7 LF; 3:1  22' COLLECTOR LANDSCAPE BUFFER: (1) TREE / 35 LF OR (1) CLASS I / 25 LF; (1) SHRUB / 7 LF; 3:1  23' LANDSCAPE BERN MR. 2' HID!  23' LANDSCAPE BUFFER: (1) CLASS II OR II TREE / 35 LF, (1) SHRUB / 7 LF, AND (1) BOULDER / 75 LF, 3:1  33' LANDSCAPE BERN OR 3' WALL @ MIN. 30% OF LF  TURF GRASS NOT TO EXCEED 50% OF BUFFER ARAS  STREET NAME  BUFFER WIDTH (FT)  LF # OF DRIVES   LF - DRIVES   SHRUB ** ** TREES  MIDLAND BLVD.  20 2.627 2 2.524 361 0 101 102*  SOARING HEIGHTS DR 15 3.236 2 3178 454 0 91 91 91  SKYGATE ST 15 2.992 4 2876 0 0 882 82  FEATHER CREST ST 10 194 0 194 0 0 6 6 6  BRAVEWING WAY 10 1,606 1 1577 0 0 45 45  BRAVEWING WAY 10 188 0 188 0 0 185  SOARCREST LP 10 188 0 188 0 0 184 0 0 15 45  SOARCREST LP 10 194 0 202 0 202 0 0 15 45 15  SKYRIN AVE 10 202 0 202 0 0 0 6 6 6  SKYRIN AVE 10 1,038 0 1036 0 0 30 30  UPDRAFT AVE 10 1,146 0 1146 0 0 136 0 0 30 30  UPDRAFT AVE 10 1,146 0 1146 0 0 1364 0 0 35 33  SOARING GAIL AVE 10 1,038 0 1036 0 0 35 30  AIR AVE 10 1,1604 2 11746 0 0 5 5 5  FEATHER TRAIL AVE 10 1,084 0 1084 0 0 0 41 41  GILDEWING AVE 10 1,084 0 1084 0 0 0 19 9 9  FEATHER TRAIL AVE 10 1,084 0 1084 0 0 0 19 9 9  FLATCHILDRED TO THE TRAIL AVE 10 1,084 0 0 0 1679 0 0 0 19 9 9  FLIGHT PATH AVE 10 3566 0 3566 0 0 10 10 10				+			+ -	_	<del>-</del>
9   90   215   32   0   0   1						1	+ -		-
STREET CALCULATIONS						<b> </b>	+		-
10   LOCAL LANDSCAPE BUFFER: (1) CLASS    TREE   35    F OR (1) CLASS    25    F	TOTAL PATH	WAY TREES				1	1	97	105
STREET NAME	10' LOCAL LANDSCAPE E 20' COLLECTOR LANDSCA 25' MINOR ARTERIAL LAI LANDSCAPE BERM MIN. 2 35' HWY 20/26 LANDSC 3:1 LANDSCAPE BERM O TURF GRASS NOT TO EX	BUFFER: (1) CLASS II APE BUFFER: (1) TREE NDSCAPE BUFFER: (1) 2' HIGH APE BUFFER: (1) CLA OR 3' WALL @ MIN. 30 CCEED 50% OF BUFFER	TREE / 35 LF TREE / 3 SS II OR II % OF LF AREAS	OR (1) CLASS I , 5 LF OR (1) CLASS TREE / 35 LF, (1	/ 25 LF; (1) SHF S I / 25 LF; (1) ) SHRUB / 7 LF	SHRUB , AND (	/ 7 LF;	DER /	
SOARING HEIGHTS DR 15 3,236 2 3178 454 0 91 91 SKYGATE ST 15 2,992 4 2876 0 0 82 82 FEATHER CREST ST 10 194 0 194 0 0 6 6 8 BRAVEWING WAY 10 1,606 1 1577 0 0 45 45 45 PLUME AVE 10 188 0 188 0 0 5 5 5 SOARCREST LP 10 5,466 3 5379 0 0 154 154 EAGLE WING AVE 10 202 0 202 0 0 6 6 8 SKYRUN AVE 10 202 0 202 0 0 6 6 8 SKYRUN AVE 10 202 0 202 0 0 6 6 8 SWIFTLIGHT ST 10 3,140 7 2937 0 0 84 84 AERIAL HEIGHTS AVE 10 1,036 0 1036 0 0 30 30 UPDRAFT AVE 10 1,058 0 1058 0 0 30 30 AIR AVE 10 1,146 0 1146 0 0 33 33 33 SOARING GAIL AVE 10 1,236 0 1236 0 0 35 35 FEATHERTAIL ST 10 1,804 2 1746 0 0 50 50 FEATHER FALL AVE 10 1,084 0 1084 0 0 31 31 31 GILDEWING AVE 10 1,084 0 1084 0 0 31 31 31 GILDEWING AVE 10 1,504 2 1446 0 0 41 41 GILDEWING AVE 10 1,504 2 1446 0 0 9 9 9 HATCHLING CT 10 10 679 0 679 0 0 19 19 FILIGHT PATH AVE 10 356 0 356 0 0 10 10 10 10 10 10 10 10 10 10 10 10		. ,				REQ	PRVD	REQ	PRVD
SKYGATE ST 15 2,992 4 2876 0 0 82 82 82 82 84 85 86 87 87 87 87 87 87 87 87 87 87 87 87 87	MIDLAND BLVD. SOARING HEIGHTS DR						+ -		
BRAVEWING WAY 10 1,606 1 1577 0 0 45 45 PLUME AVE 10 188 0 188 0 0 5 5 5 SOARCREST LP 10 5,466 3 5379 0 0 154 154 EAGLE WING AVE 10 202 0 202 0 0 6 6 SKYRUN AVE 10 202 0 202 0 0 6 6 SWIFTLIGHT ST 10 3,140 7 2937 0 0 84 84 AERIAL HEIGHTS AVE 10 1,036 0 1036 0 0 30 30 UPDRAFT AVE 10 1,058 0 1058 0 0 30 30 AIR AVE 10 1,146 0 1146 0 0 33 33 33 SOARING GAIL AVE 10 1,236 0 1236 0 0 35 35 FEATHER FALL AVE 10 1,804 2 1746 0 0 50 50 FEATHER FALL AVE 10 1,342 0 1342 0 0 38 38 PERCH VIEW DR 10 1,084 0 1084 0 0 31 31 GILDEWING AVE 10 1,504 2 1446 0 0 41 41 GILDEWING PL 10 316 0 356 0 0 19 19 FLIGHT PATH AVE 10 356 0 356 0 0 10 19 19 FLIGHT PATH AVE 10 356 0 356 0 0 10 19 19	SKYGATE ST	15	2,992	4	2876	-	+ -		82
PLUME AVE 10 188 0 188 0 0 5 5 5 SOARCREST LP 10 5,466 3 5379 0 0 154 154 EAGLE WING AVE 10 202 0 202 0 0 6 6 8 SKYRUN AVE 10 202 0 202 0 0 6 6 8 SWIFTLIGHT ST 10 3,140 7 2937 0 0 84 84 AERIAL HEIGHTS AVE 10 1,036 0 1036 0 0 30 30 UPDRAFT AVE 10 1,058 0 1058 0 0 30 30 AIR AVE 10 1,146 0 1146 0 0 33 33 33 SOARING GAIL AVE 10 1,236 0 1236 0 0 35 35 FEATHER FALL AVE 10 1,804 2 1746 0 0 50 50 FEATHER FALL AVE 10 1,084 0 1084 0 0 31 31 GILDEWING AVE 10 1,084 0 1084 0 0 31 31 GILDEWING AVE 10 1,504 2 1446 0 0 41 41 GILDEWING PL 10 316 0 356 0 0 19 19 FLIGHT PATH AVE 10 356 0 356 0 0 10 10 10							+ -		-
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SKYRUN AVE         10         202         0         202         0         6         6           SWIFTLIGHT ST         10         3,140         7         2937         0         0         84         84           AERIAL HEIGHTS AVE         10         1,036         0         1036         0         0         30         30           UPDRAFT AVE         10         1,058         0         1058         0         0         30         30           AIR AVE         10         1,146         0         1146         0         0         33         33           SOARING GAIL AVE         10         1,236         0         1236         0         0         35         35           FEATHERTAIL ST         10         1,804         2         1746         0         0         50         50           FEATHER FALL AVE         10         1,342         0         1342         0         0         38         38           PERCH VIEW DR         10         1,084         0         1084         0         0         31         31           GILDEWING AVE         10         316         0         316         0         0			<u> </u>			_	+ -		
AERIAL HEIGHTS AVE 10 1,036 0 1036 0 0 30 30 UPDRAFT AVE 10 1,058 0 1058 0 0 30 30 AIR AVE 10 1,146 0 1146 0 0 33 33 33 SOARING GAIL AVE 10 1,236 0 1236 0 0 35 35 FEATHERTAIL ST 10 1,804 2 1746 0 0 50 50 FEATHER FALL AVE 10 1,342 0 1342 0 0 38 38 PERCH VIEW DR 10 1,084 0 1084 0 0 31 31 GILDEWING AVE 10 1,504 2 1446 0 0 41 41 GILDEWING PL 10 316 0 316 0 0 9 9 HATCHLING CT 10 356 0 356 0 0 10 10				-		_	+ -		
UPDRAFT AVE         10         1,058         0         1058         0         0         30         30           AIR AVE         10         1,146         0         1146         0         0         33         33           SOARING GAIL AVE         10         1,236         0         1236         0         0         35         35           FEATHERTAIL ST         10         1,804         2         1746         0         0         50         50           FEATHER FALL AVE         10         1,342         0         1342         0         0         38         38           PERCH VIEW DR         10         1,084         0         1084         0         0         31         31           GILDEWING AVE         10         1,504         2         1446         0         0         41         41           GILDEWING PL         10         316         0         316         0         0         9         9           HATCHLING CT         10         679         0         679         0         0         19         19           FLIGHT PATH AVE         10         356         0         356         0			-			ļ			
SOARING GAIL AVE         10         1,236         0         1236         0         0         35         35           FEATHERTAIL ST         10         1,804         2         1746         0         0         50         50           FEATHER FALL AVE         10         1,342         0         1342         0         0         38         38           PERCH VIEW DR         10         1,084         0         1084         0         0         31         31           GILDEWING AVE         10         1,504         2         1446         0         0         41         41           GILDEWING PL         10         316         0         316         0         0         9         9           HATCHLING CT         10         679         0         679         0         0         19         19           FLIGHT PATH AVE         10         356         0         356         0         0         10         10	SWIFTLIGHT ST	+	1,058	0	1058	0	0	30	30
FEATHERTAIL ST         10         1,804         2         1746         0         0         50         50           FEATHER FALL AVE         10         1,342         0         1342         0         0         38         38           PERCH VIEW DR         10         1,084         0         1084         0         0         31         31           GILDEWING AVE         10         1,504         2         1446         0         0         41         41           GILDEWING PL         10         316         0         316         0         0         9         9           HATCHLING CT         10         679         0         679         0         0         19         19           FLIGHT PATH AVE         10         356         0         356         0         0         10         10	SWIFTLIGHT ST AERIAL HEIGHTS AVE UPDRAFT AVE		1,146			_	+ -		
PERCH VIEW DR         10         1,084         0         1084         0         31         31           GILDEWING AVE         10         1,504         2         1446         0         0         41         41           GILDEWING PL         10         316         0         316         0         0         9         9           HATCHLING CT         10         679         0         679         0         0         19         19           FLIGHT PATH AVE         10         356         0         356         0         0         10         10	SWIFTLIGHT ST AERIAL HEIGHTS AVE UPDRAFT AVE AIR AVE	10	1,236				+ -	50	
GILDEWING AVE 10 1,504 2 1446 0 0 41 41  GILDEWING PL 10 316 0 316 0 0 9 9  HATCHLING CT 10 679 0 679 0 0 19 19  FLIGHT PATH AVE 10 356 0 356 0 0 10	SWIFTLIGHT ST AERIAL HEIGHTS AVE UPDRAFT AVE AIR AVE SOARING GAIL AVE FEATHERTAIL ST	10			1740				
HATCHLING CT         10         679         0         679         0         0         19         19           FLIGHT PATH AVE         10         356         0         356         0         0         10         10	SWIFTLIGHT ST AERIAL HEIGHTS AVE UPDRAFT AVE AIR AVE SOARING GAIL AVE FEATHER FALL AVE	10 10 10 10	1,804 1,342	2 0	1342		+ -		
FLIGHT PATH AVE 10 356 0 0 10 10	SWIFTLIGHT ST AERIAL HEIGHTS AVE UPDRAFT AVE AIR AVE SOARING GAIL AVE FEATHERTAIL ST FEATHER FALL AVE PERCH VIEW DR	10 10 10 10 10	1,804 1,342 1,084	2 0 0	1342 1084	0	0	31	31
TOTAL STREET TREES 940 907	SWIFTLIGHT ST AERIAL HEIGHTS AVE UPDRAFT AVE AIR AVE SOARING GAIL AVE FEATHERTAIL ST FEATHER FALL AVE PERCH VIEW DR GILDEWING AVE	10 10 10 10 10 10 10	1,804 1,342 1,084 1,504 316	2 0 0 2 0	1342 1084 1446 316	0 0	0 0	31 41 9	31 41 9
	SWIFTLIGHT ST AERIAL HEIGHTS AVE UPDRAFT AVE AIR AVE SOARING GAIL AVE FEATHERTAIL ST FEATHER FALL AVE PERCH VIEW DR GILDEWING AVE GILDEWING PL HATCHLING CT	10 10 10 10 10 10 10	1,804 1,342 1,084 1,504 316 679	2 0 0 2 0	1342 1084 1446 316 679	0 0 0	0 0 0	31 41 9 19	31 41 9 19

<sup>\*</sup> CLASS I TREES PROVIDED AT A 1:25' RATIO DUE TO OVER HEAD POWER. \*\* SHRUBS TO BE PROVIDED WITH INDIVIDUAL PHASING PLANS - SEE PLANTER BED HATCH WITH SUGGESTED PLANTINGS ON PPL9.0.



LANDSCAPE CONSULTANT KM ENGINEERING, LLP

5725 NORTH DISCOVERY WAY

CONTACT: ALYSSA YENSEN, PLA

EMAIL: ayensen@kmengllp.com


BOISE, IDAHO 83713


PHONE: (208) 639-6939

FAX: (208) 639-6930

DEVELOPER/OWNER BRIGHTON DEVELOPMENT INC. 2929 W. NAVIGATOR DR., SUITE 400 MERIDIAN, IDAHO 83642 PHONE: (208) 378-4000 CONTACT: JON WARDLE EMAIL: jwardle@brightoncorp.com



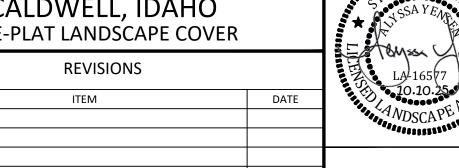

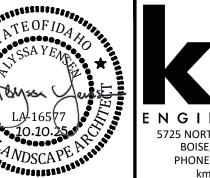


5725 NORTH DISCOVERY WAY BOISE, IDAHO 83713 PHONE (208) 639-6939 kmengllp.com

PROJECT: SHEET NO.


NOTE: SHRUB COUNT EXCLUDES ALL PERENNIALS AND GRASSES. IF PERENNIALS AND GRASSES ARE SUBSTITUTED FOR THE REQUIRED SHRUBS, THEY MUST BE PLANTED AT A MIN. 2 GAL. SIZE

PLANT PALETTE SEE PPL9.0 FOR PLANT SCHEDULE

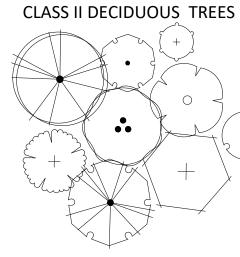


CRIMSON SENTRY MAPLE URBAN SUNSET MAPLE AUTUMN BLAZE MAPLE DURAHEAT RIVER BIRCH MULTI-TRUNK EMERALD AVANUE HORNBEAM PRINCETON SENCTRY GINKGO SUNBURST HONEYLOCUST COLUMNAR SWEET GUM GREEKSPIRE LITTLELEAF LINDEN

#### CLASS I DECIDUOUS TREES

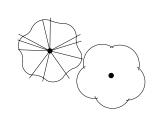


SPRING SNOW CRABAPPLE THUNDERCLOUD PRUPLE LEAF PLUM

#### **EVERGREEN TREES**

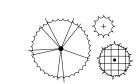

FUCHS DEODAR CEDAR BLACK HILLS SPRUCE HOOPSI BLUE SPRUCE

#### SHRUB BEDS SEE KEY NOTE #3 FOR GROUNDCOVER MATERIAL

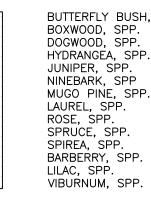

BLUE FESCUE, SPP. REED GRASS, SPP. FOUNTAIN GRASS, SPP. DIANTHUS, SPP. CONEFLOWER, SPP. DAYLILY, SPP. HOSTA, SPP. LAVENDER, SPP. BLACK-EYED SUSAN, SPP. PHLOX, SPP. SALVIA, SPP. SAGE, SPP.

MATERIAL LEGEND SEE PLANT SCHEDULE ON PPL9.0 FOR GENERAL SPECIFICATIONS

### KEY NOTES (TYPICAL) $\langle \# \rangle$

1. INSTALL 3' DIAMETER SHOVEL CUT TREE RING, WITH BARE EARTH SURFACE AT ALL TREES WITHIN TURF AREAS. DO NOT INSTALL TREE RINGS FOR TREES WITHIN HYDROSEEDED AREAS.

NO-MOW FESCUE


- 2. 40' CLEAR VISION TRIANGLE. NO TREES SHALL BE PLANTED WITHIN A CLEAR VISION TRIANGLE. THE MAXIMUM HEIGHT OF ANY VEGETATIVE GROUND COVER AT MATURITY WITHIN THE CLEAR VISION TRIANGLE SHALL BE 3' FROM THE ADJACENT STREET GRADE.
- 3. ALL PLANTED BEDS TO RECEIVE A MIN. 3" DEPTH OF 1" BLACK AND TAN ROCK MULCH WITH PERMEABLE FABRIC WEED BARRIER. SUBMIT SAMPLE TO OWNER FOR APPROVAL PRIOR TO ORDERING AND INSTALLING. THE USE OF MULCH OR ROCK AS THE ONLY GROUND COVER IN REQUIRED PLANTING ARES IS PROHIBITED. IMPERMEABLE PLASTIC WEED BARRIERS ARE
- 4. TREES PLANTED IN PARK STRIPS TO BE CENTERED IN STRIP.
- 5. INSTALL FLAT-BLADE SHOVEL EDGING AT INTERFACE OF SOD AND PLANTER BED & PLANTER
- 6. OPEN VISION FENCE SEE PPL8.0 FOR FENCE PLAN.
- 7. CLOSED VISION FENCE SEE PPL8.0 FOR FENCE PLAN.
- 8. 3:1 LANDSCAPE BERM HEIGHT VARIES BETWEEN 2' 4'.
- 9. CLUBHOUSE & POOL LAYOUT IS SCHEMATIC AND SHOWN FOR ILLUSTRATIVE PURPOSES ONLY. FINAL LAYOUT TO BE APPROVED THROUGH SEPARATE SUBMITTAL.
- 10. TOT LOT WITH SEATING PLAY EQUIPMENT IS SHOWN FOR ILLUSTRATIVE PURPOSES ONLY. FINAL LAYOUT AND SPECIFICATIONS TO BE APPROVED AS A PART OF CORRESPONDING PHASE
- 11. BBQ STATION WITH SHADE STRUCTURE SHOWN FOR ILLUSTRATIVE PURPOSES ONLY. FINAL LAYOUT AND SPECIFICATIONS TO BE APPROVED AS A PART OF CORRESPONDING PHASE LANDSCAPE PLAN.
- 12. WILDLIFE OBSERVATION GARDEN INFORMATIONAL SIGNAGE, CUSTOM SEATING AREAS, & BIRD NESTING ZONE IS SHOWN FOR ILLUSTRATIVE PURPOSES ONLY. FINAL LAYOUT AND SPECIFICATIONS TO BE APPROVED AS A PART OF CORRESPONDING PHASE LANDSCAPE PLAN.
- 13. BIKE REPAIR STATION WITH SEATING- SHOWN FOR ILLUSTRATIVE PURPOSES ONLY. FINAL LAYOUT AND SPECIFICATIONS TO BE APPROVED AS A PART OF CORRESPONDING PHASE LANDSCAPE
- 14. DOG PARK (2) DOUBLE GATED ENTRIES, ADA ACCESS, AND SEATING AREAS ARE SHOWN FOR ILLUSTRATIVE PURPOSES ONLY. FINAL LAYOUT AND SPECIFICATIONS TO BE APPROVED AS A PART OF CORRESPONDING PHASE LANDSCAPE PLAN.
- 15. LANDSCAPE STREET BUFFERS TO BE DESIGNED WITH CORRESPONDING PHASE LANDSCAPE PLAN. INTERNAL STREET FRONTAGE BUFFERS TO BE INSTALLED POST COMPLETION OF LOT.
- 16. LANDSCAPE BOULDERS WEISER BROWN OR APPROVED EQUAL. SIZES SHALL VARY BETWEEN 2
- 17. LANDSCAPE BOULDER WALL WEISER BROWN OR APPROVED EQUAL. FINAL HEIGHTS AND LOCATION PER CIVIL CONSTRUCTION PLANS.

AVIARY HEIGHTS SUBDIVISION CALDWELL, IDAHO PRE-PLAT LANDSCAPE PLAN	
REVISIONS	ES.
NO. ITEM DATE	



5725 NORTH DISCOVERY WAY BOISE, IDAHO 83713 PHONE (208) 639-6939 kmengllp.com

PROJECT: SHEET NO. PPL2.0

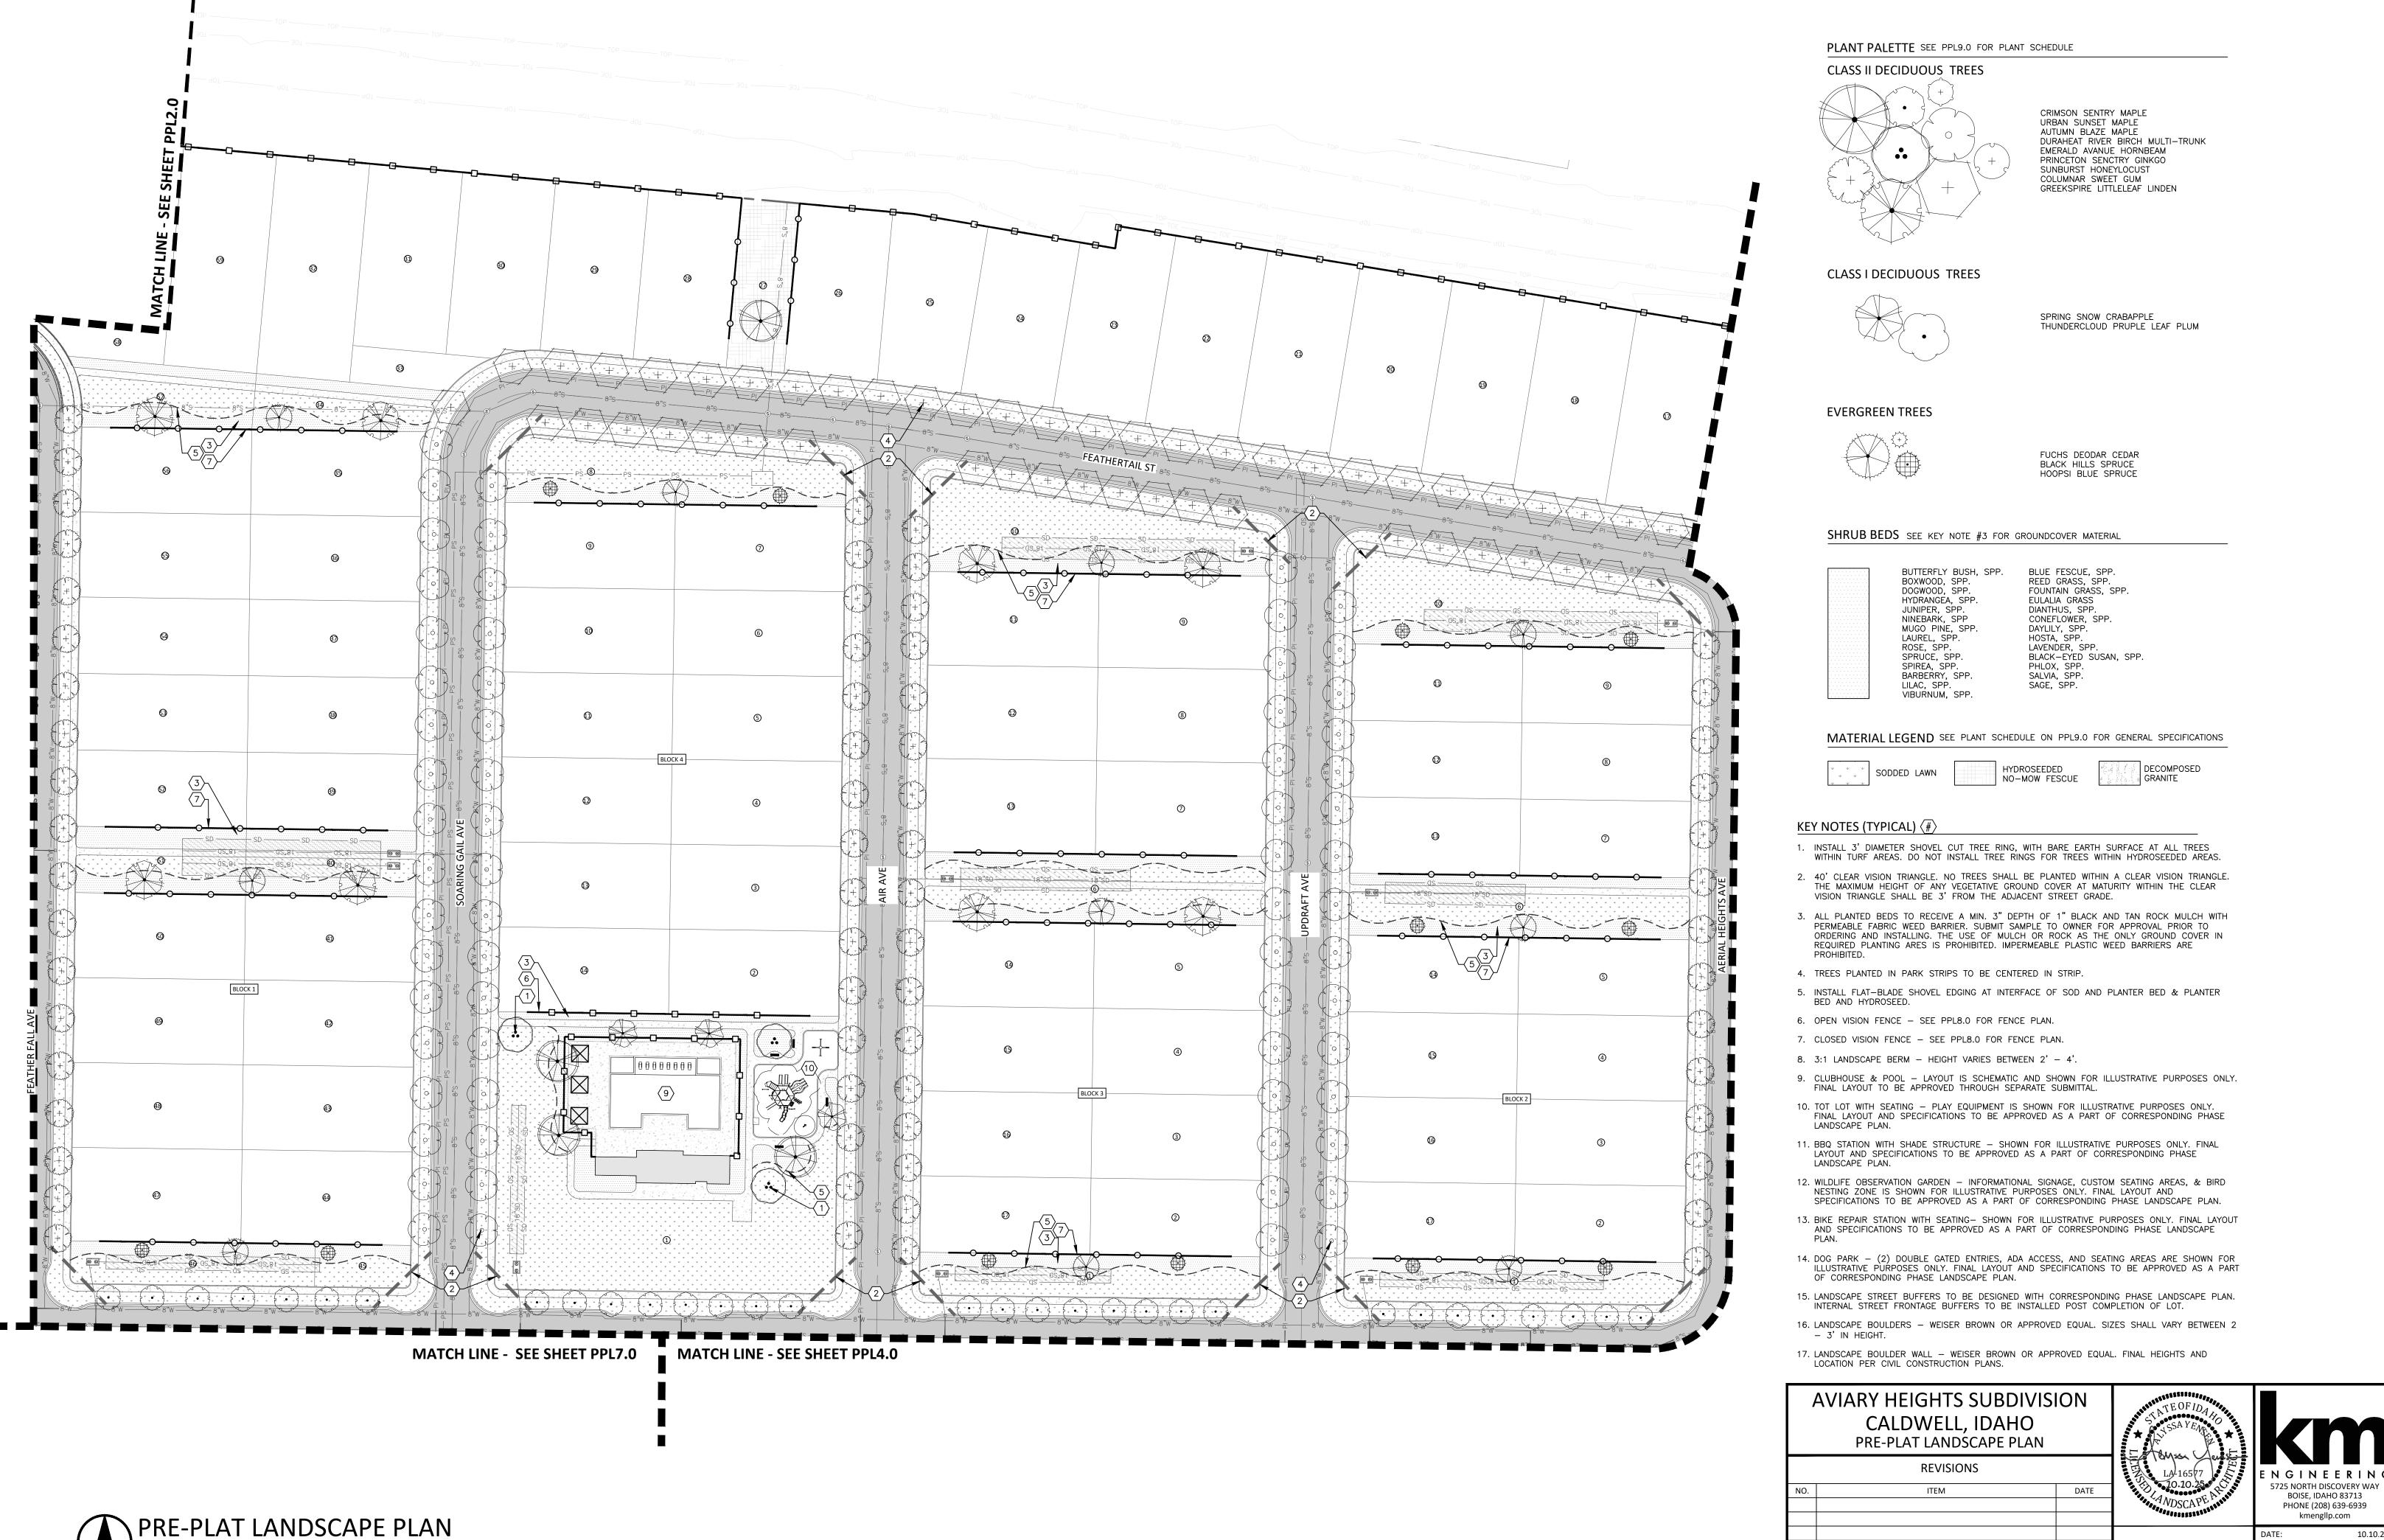

P:\22-227\CAD\LANDSCAPE\ENTITLEMENTS\22-227 PPL1.0.DWG, BROOKE LOVELACE, 10/10/2025, CANON IPF755 (BW).PC3, 24X36 L [PDF]

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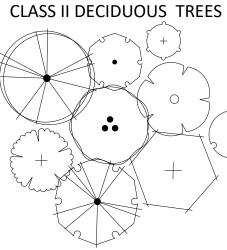
DATE: 10.10.25

PROJECT: 22-227

SHEET NO.


PPL3.0

PLANT PALETTE SEE PPL9.0 FOR PLANT SCHEDULE




CRIMSON SENTRY MAPLE URBAN SUNSET MAPLE AUTUMN BLAZE MAPLE DURAHEAT RIVER BIRCH MULTI-TRUNK EMERALD AVANUE HORNBEAM PRINCETON SENCTRY GINKGO SUNBURST HONEYLOCUST COLUMNAR SWEET GUM GREEKSPIRE LITTLELEAF LINDEN

#### CLASS I DECIDUOUS TREES

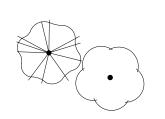


SPRING SNOW CRABAPPLE THUNDERCLOUD PRUPLE LEAF PLUM

## **EVERGREEN TREES**

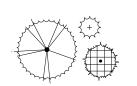

FUCHS DEODAR CEDAR BLACK HILLS SPRUCE HOOPSI BLUE SPRUCE

#### SHRUB BEDS SEE KEY NOTE #3 FOR GROUNDCOVER MATERIAL

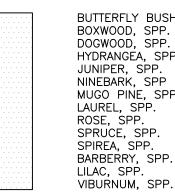

BOXWOOD, SPP. DOGWOOD, SPP. HYDRANGEA, SPP. JUNIPER, SPP. NINEBARK, SPP MUGO PINE, SPP. LAUREL, SPP. SPRUCE, SPP. SPIREA, SPP. BARBERRY, SPP. LILAC, SPP.

BLUE FESCUE, SPP. REED GRASS, SPP. FOUNTAIN GRASS, SPP. EULALIA GRASS DIANTHUS, SPP. CONEFLOWER, SPP. DAYLILY, SPP. HOSTA, SPP. LAVENDER, SPP. BLACK-EYED SUSAN, SPP. PHLOX, SPP. SALVIA, SPP. SAGE, SPP.


### MATERIAL LEGEND SEE PLANT SCHEDULE ON PPL9.0 FOR GENERAL SPECIFICATIONS


HYDROSEEDED NO-MOW FESCUE

## KEY NOTES (TYPICAL) (#)

- 1. INSTALL 3' DIAMETER SHOVEL CUT TREE RING, WITH BARE EARTH SURFACE AT ALL TREES WITHIN TURF AREAS. DO NOT INSTALL TREE RINGS FOR TREES WITHIN HYDROSEEDED AREAS.
- 2. 40' CLEAR VISION TRIANGLE. NO TREES SHALL BE PLANTED WITHIN A CLEAR VISION TRIANGLE. THE MAXIMUM HEIGHT OF ANY VEGETATIVE GROUND COVER AT MATURITY WITHIN THE CLEAR VISION TRIANGLE SHALL BE 3' FROM THE ADJACENT STREET GRADE.
- 3. ALL PLANTED BEDS TO RECEIVE A MIN. 3" DEPTH OF 1" BLACK AND TAN ROCK MULCH WITH PERMEABLE FABRIC WEED BARRIER. SUBMIT SAMPLE TO OWNER FOR APPROVAL PRIOR TO ORDERING AND INSTALLING. THE USE OF MULCH OR ROCK AS THE ONLY GROUND COVER IN REQUIRED PLANTING ARES IS PROHIBITED. IMPERMEABLE PLASTIC WEED BARRIERS ARE PROHIBITED.
- 4. TREES PLANTED IN PARK STRIPS TO BE CENTERED IN STRIP.
- 5. INSTALL FLAT-BLADE SHOVEL EDGING AT INTERFACE OF SOD AND PLANTER BED & PLANTER BED AND HYDROSEED.
- 6. OPEN VISION FENCE SEE PPL8.0 FOR FENCE PLAN.
- 7. CLOSED VISION FENCE SEE PPL8.0 FOR FENCE PLAN.
- 8. 3:1 LANDSCAPE BERM HEIGHT VARIES BETWEEN 2' 4'.
- 9. CLUBHOUSE & POOL LAYOUT IS SCHEMATIC AND SHOWN FOR ILLUSTRATIVE PURPOSES ONLY. FINAL LAYOUT TO BE APPROVED THROUGH SEPARATE SUBMITTAL.
- 10. TOT LOT WITH SEATING PLAY EQUIPMENT IS SHOWN FOR ILLUSTRATIVE PURPOSES ONLY. FINAL LAYOUT AND SPECIFICATIONS TO BE APPROVED AS A PART OF CORRESPONDING PHASE LANDSCAPE PLAN.
- 11. BBQ STATION WITH SHADE STRUCTURE SHOWN FOR ILLUSTRATIVE PURPOSES ONLY. FINAL LAYOUT AND SPECIFICATIONS TO BE APPROVED AS A PART OF CORRESPONDING PHASE
- 12. WILDLIFE OBSERVATION GARDEN INFORMATIONAL SIGNAGE, CUSTOM SEATING AREAS, & BIRD NESTING ZONE IS SHOWN FOR ILLUSTRATIVE PURPOSES ONLY. FINAL LAYOUT AND SPECIFICATIONS TO BE APPROVED AS A PART OF CORRESPONDING PHASE LANDSCAPE PLAN.
- 13. BIKE REPAIR STATION WITH SEATING— SHOWN FOR ILLUSTRATIVE PURPOSES ONLY. FINAL LAYOUT AND SPECIFICATIONS TO BE APPROVED AS A PART OF CORRESPONDING PHASE LANDSCAPE
- 14. DOG PARK (2) DOUBLE GATED ENTRIES, ADA ACCESS, AND SEATING AREAS ARE SHOWN FOR ILLUSTRATIVE PÙRPOSES ONLY. FINAL LAYOUT AND SPECIFICATIONS TO BE APPROVED AS A PART OF CORRESPONDING PHASE LANDSCAPE PLAN.
- 15. LANDSCAPE STREET BUFFERS TO BE DESIGNED WITH CORRESPONDING PHASE LANDSCAPE PLAN. INTERNAL STREET FRONTAGE BUFFERS TO BE INSTALLED POST COMPLETION OF LOT.
- 16. LANDSCAPE BOULDERS WEISER BROWN OR APPROVED EQUAL. SIZES SHALL VARY BETWEEN 2 – 3' IN HEIGHT.
- 17. LANDSCAPE BOULDER WALL WEISER BROWN OR APPROVED EQUAL. FINAL HEIGHTS AND LOCATION PER CIVIL CONSTRUCTION PLANS.

# AVIARY HEIGHTS SUBDIVISION CALDWELL, IDAHO PRE-PLAT LANDSCAPE PLAN

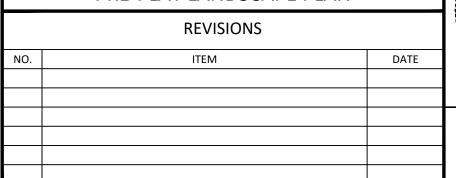


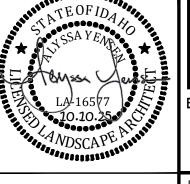

BOISE, IDAHO 83713 PHONE (208) 639-6939 kmengllp.com PROJECT:


5725 NORTH DISCOVERY WAY

SHEET NO. PPL4.0

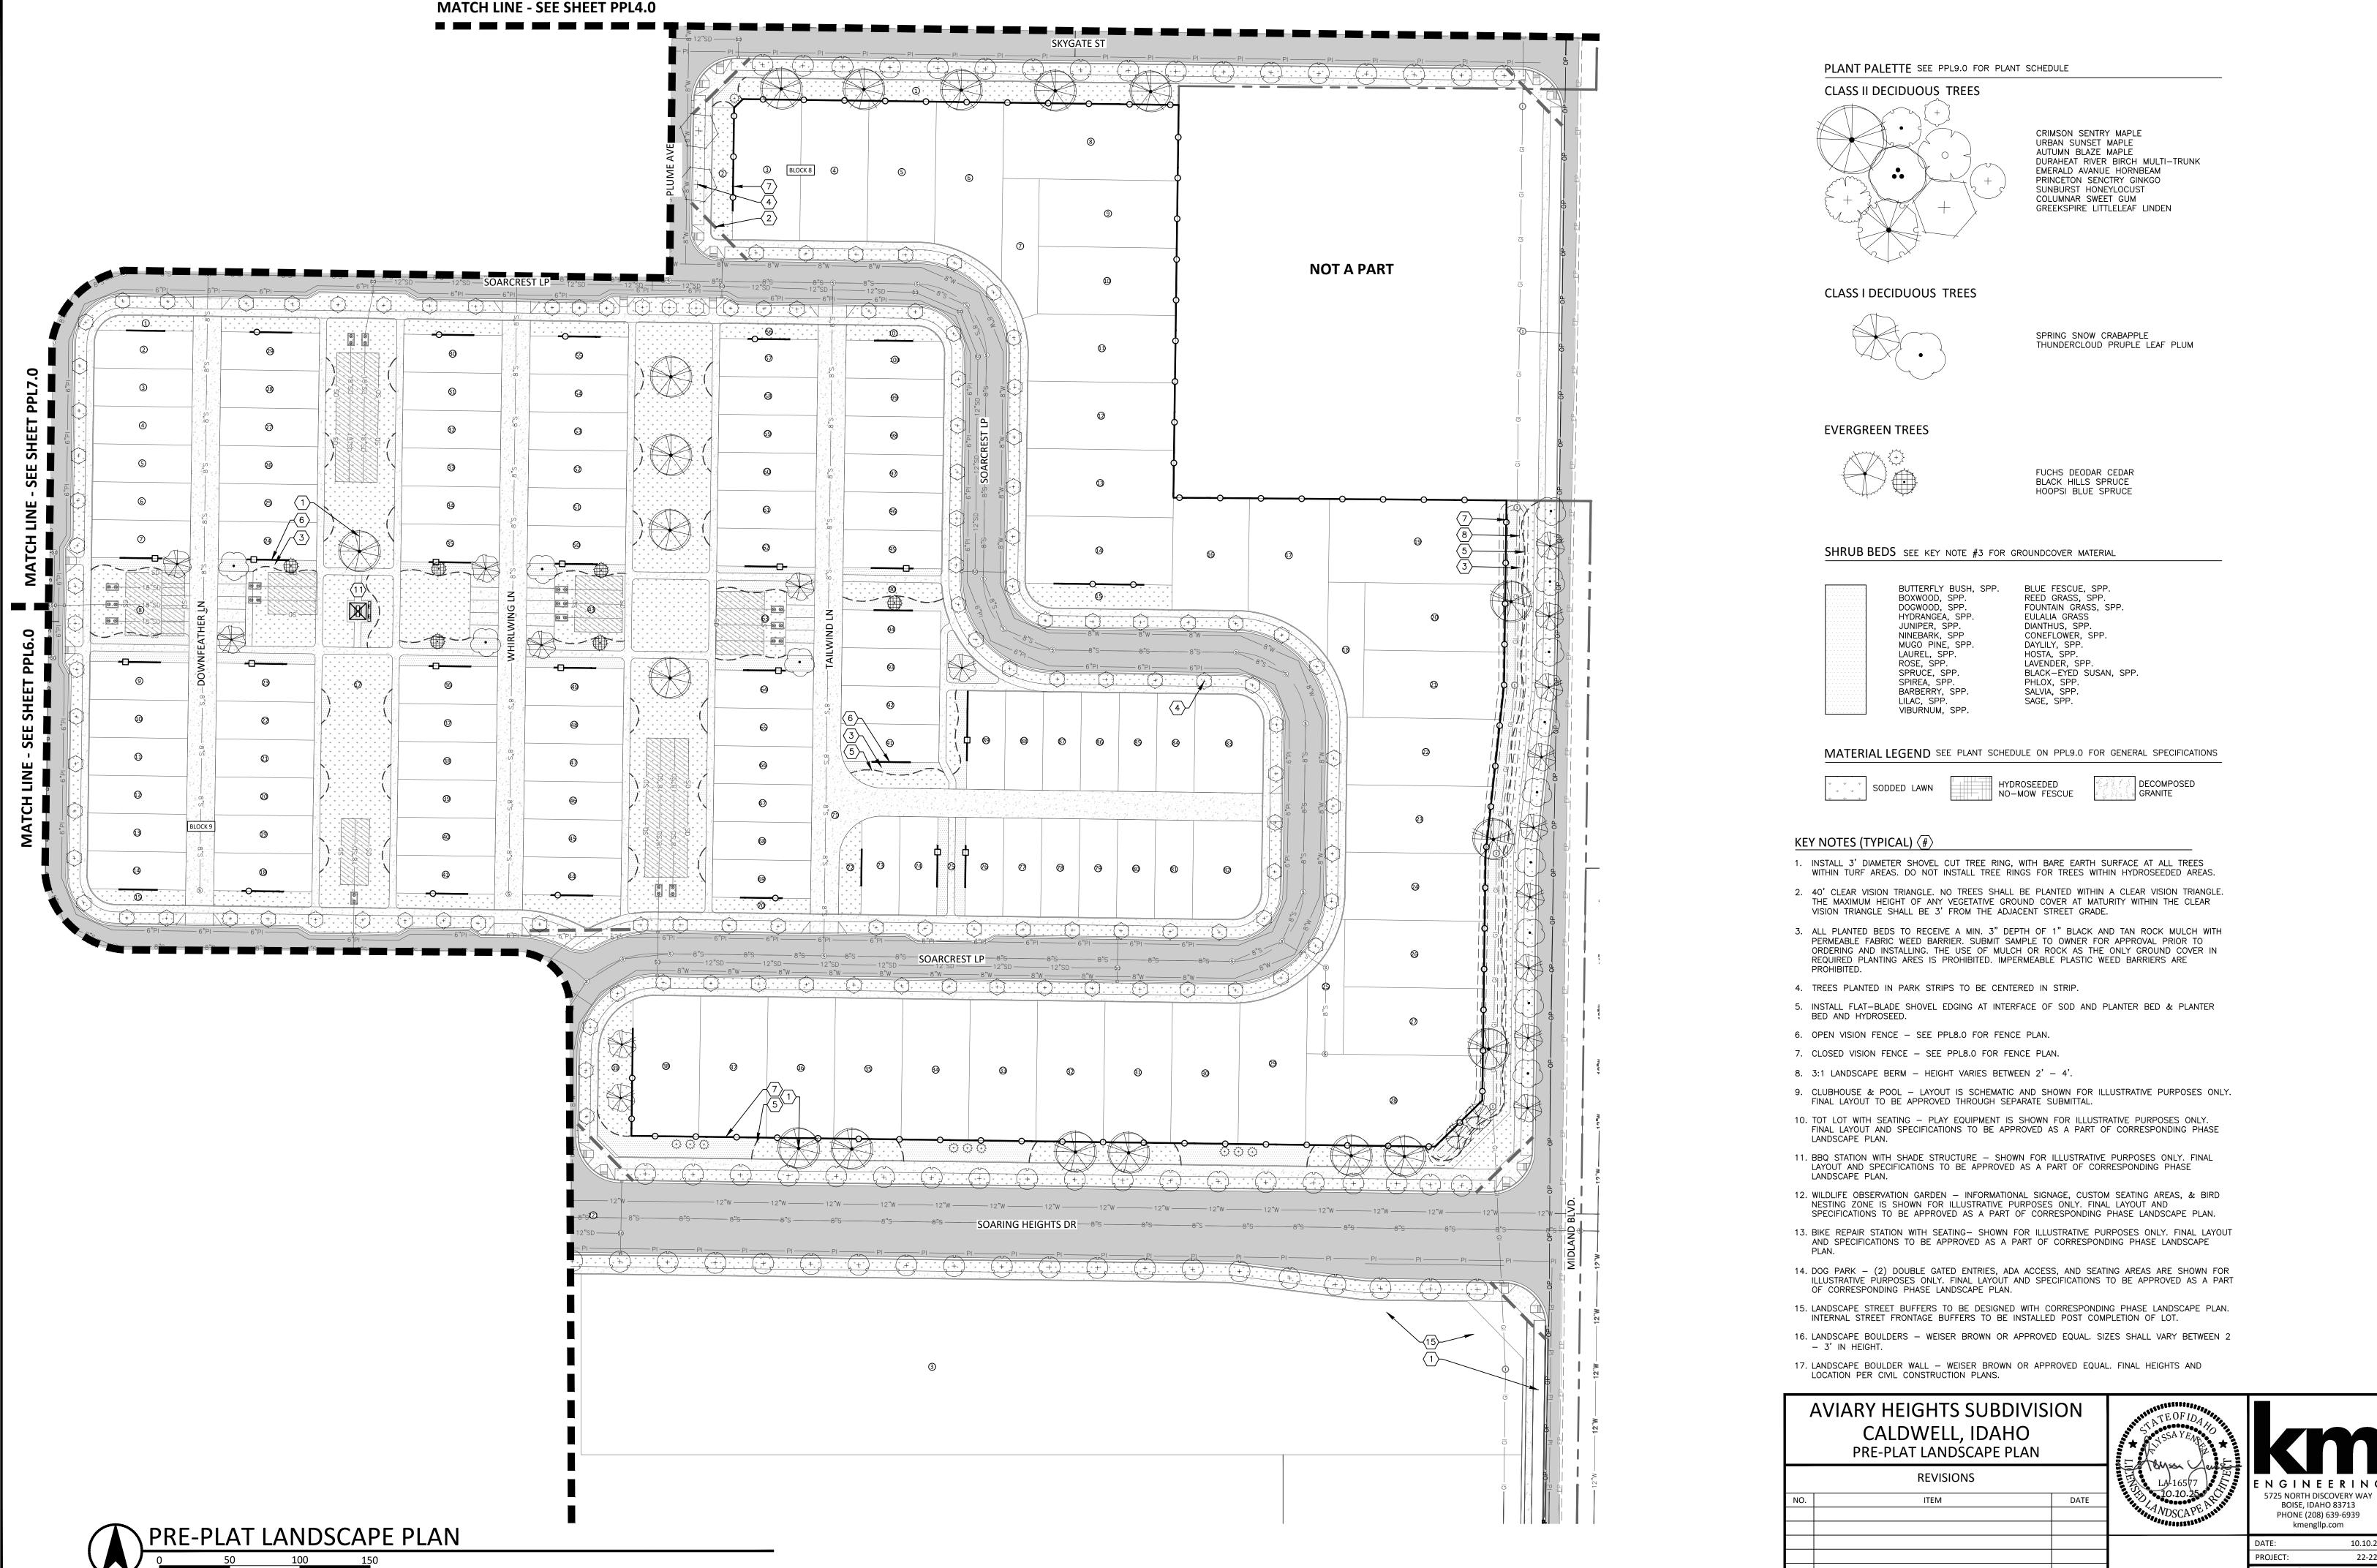

PHONE (208) 639-6939 kmengllp.com SHEET NO.

PPL5.0

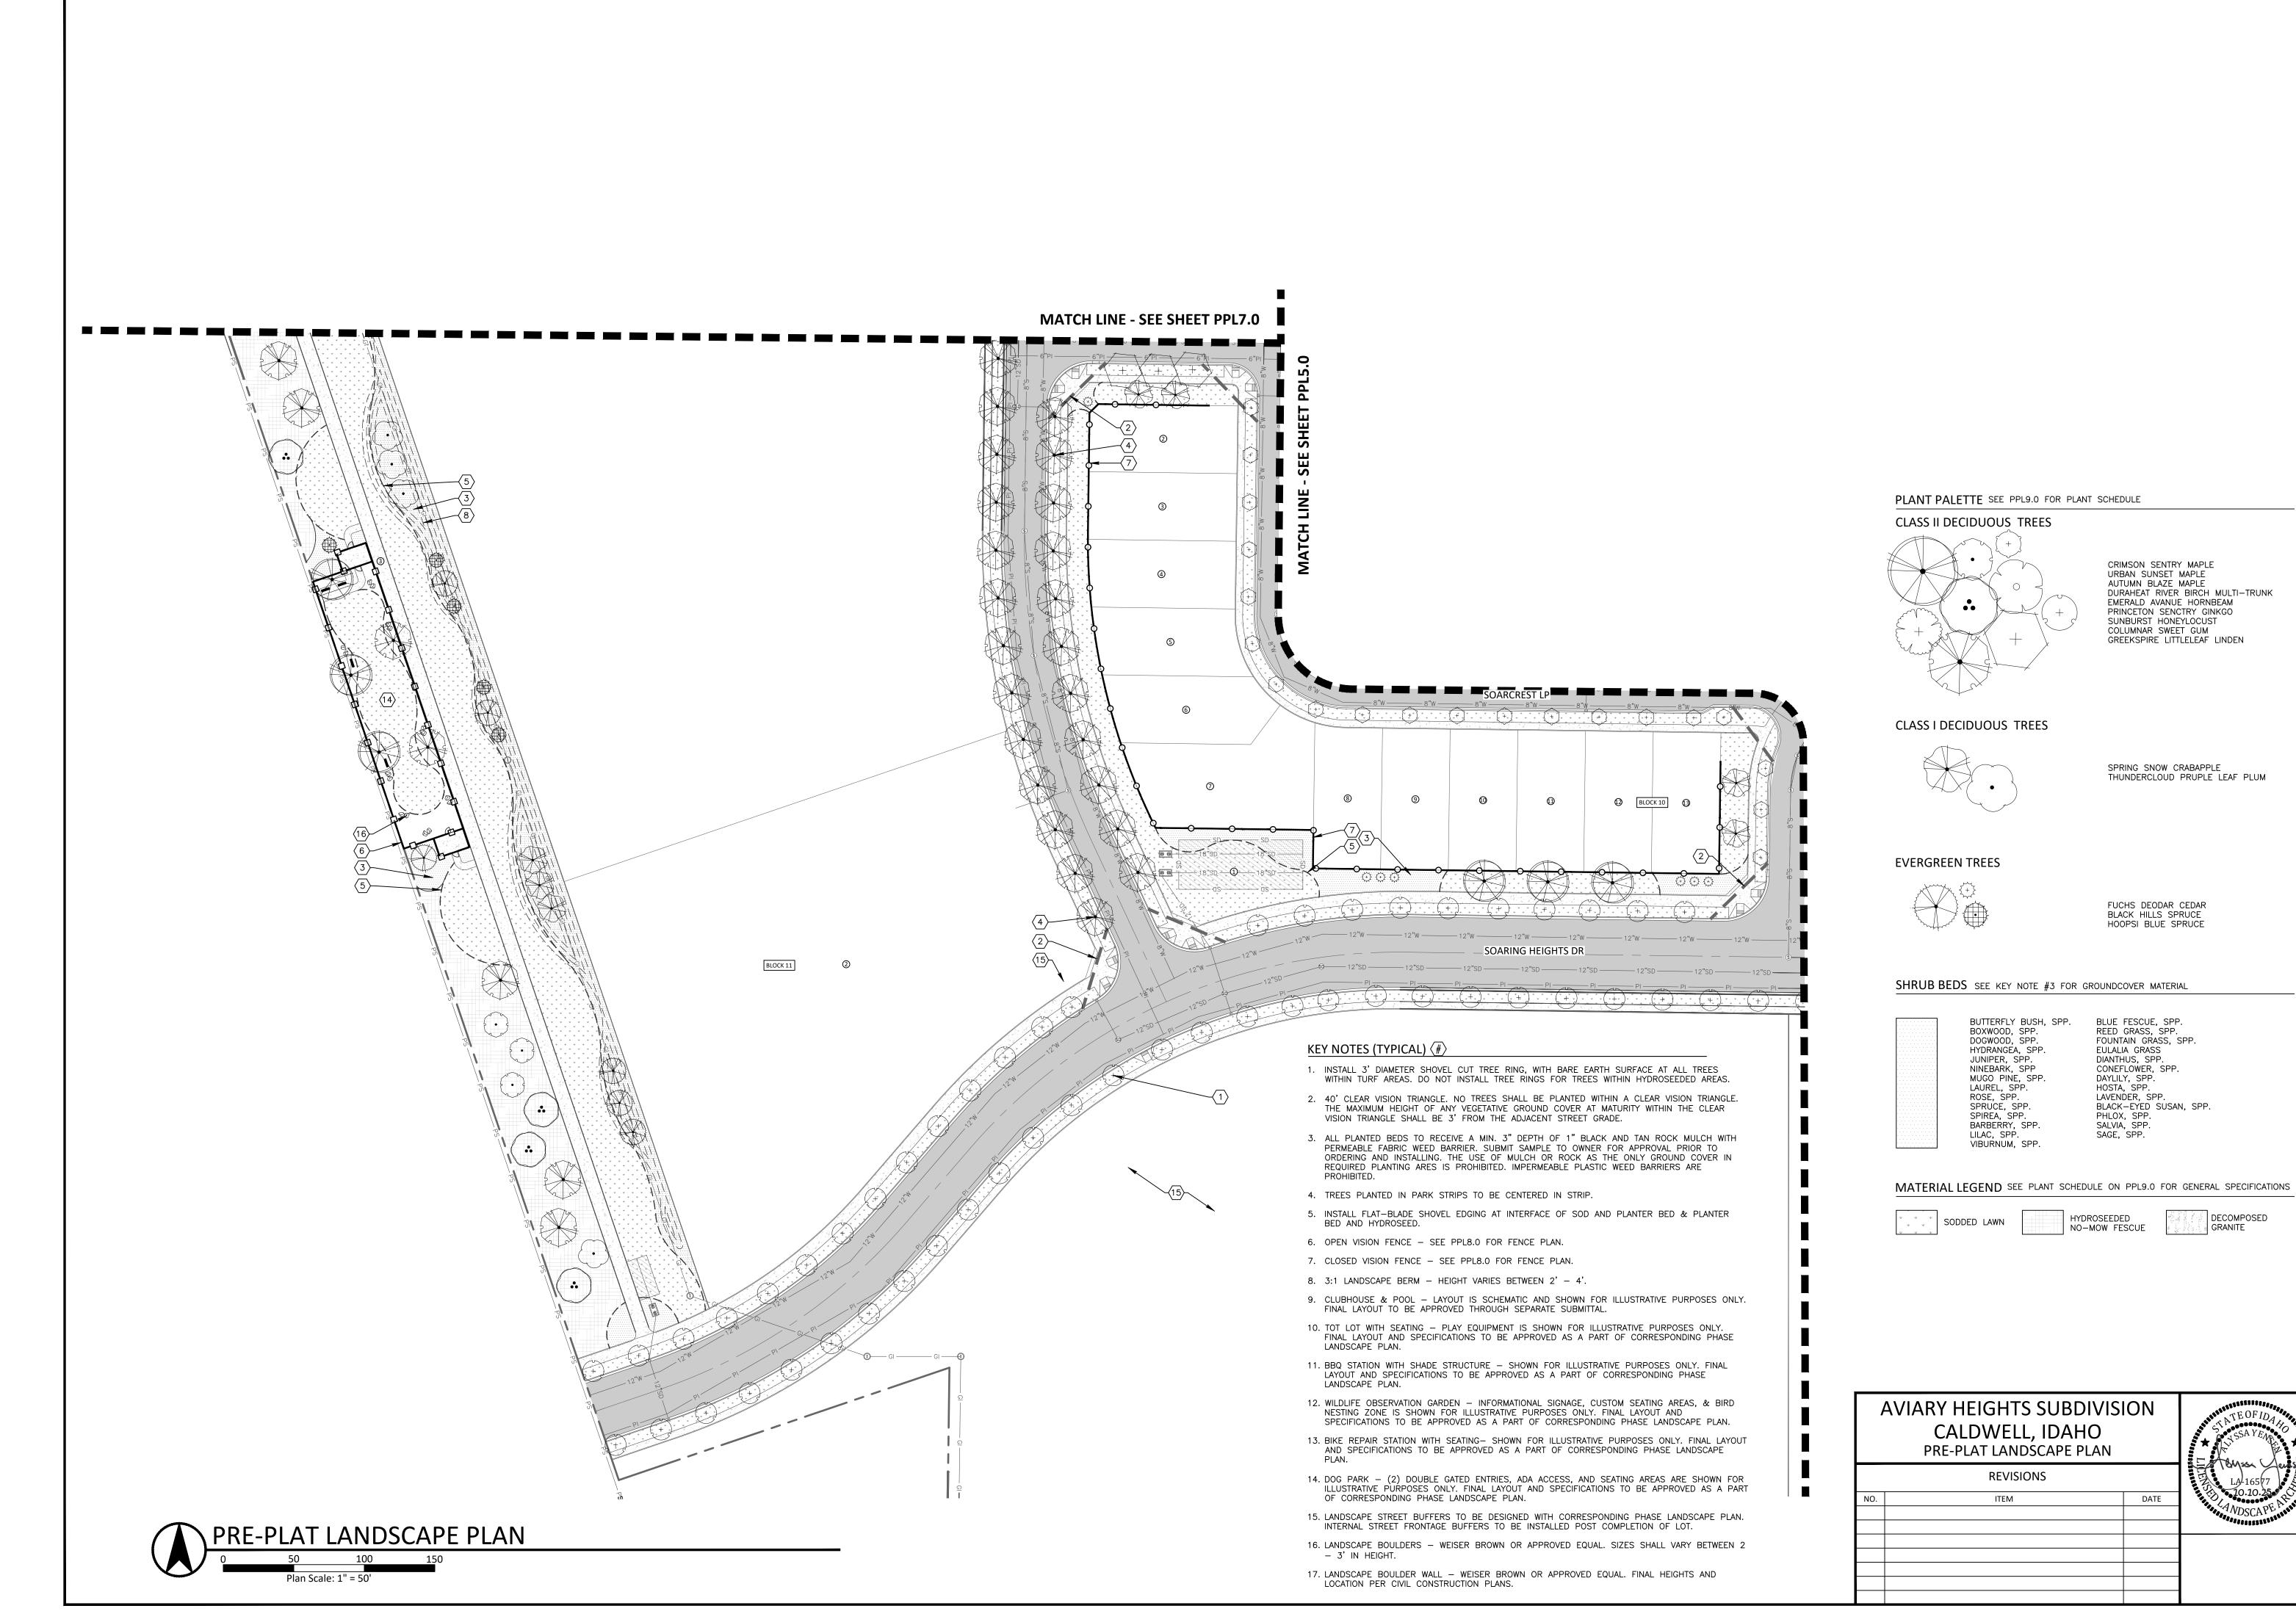



PROJECT: SHEET NO. PPL6.0

5725 NORTH DISCOVERY WAY

BOISE, IDAHO 83713 PHONE (208) 639-6939

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PPL8.0

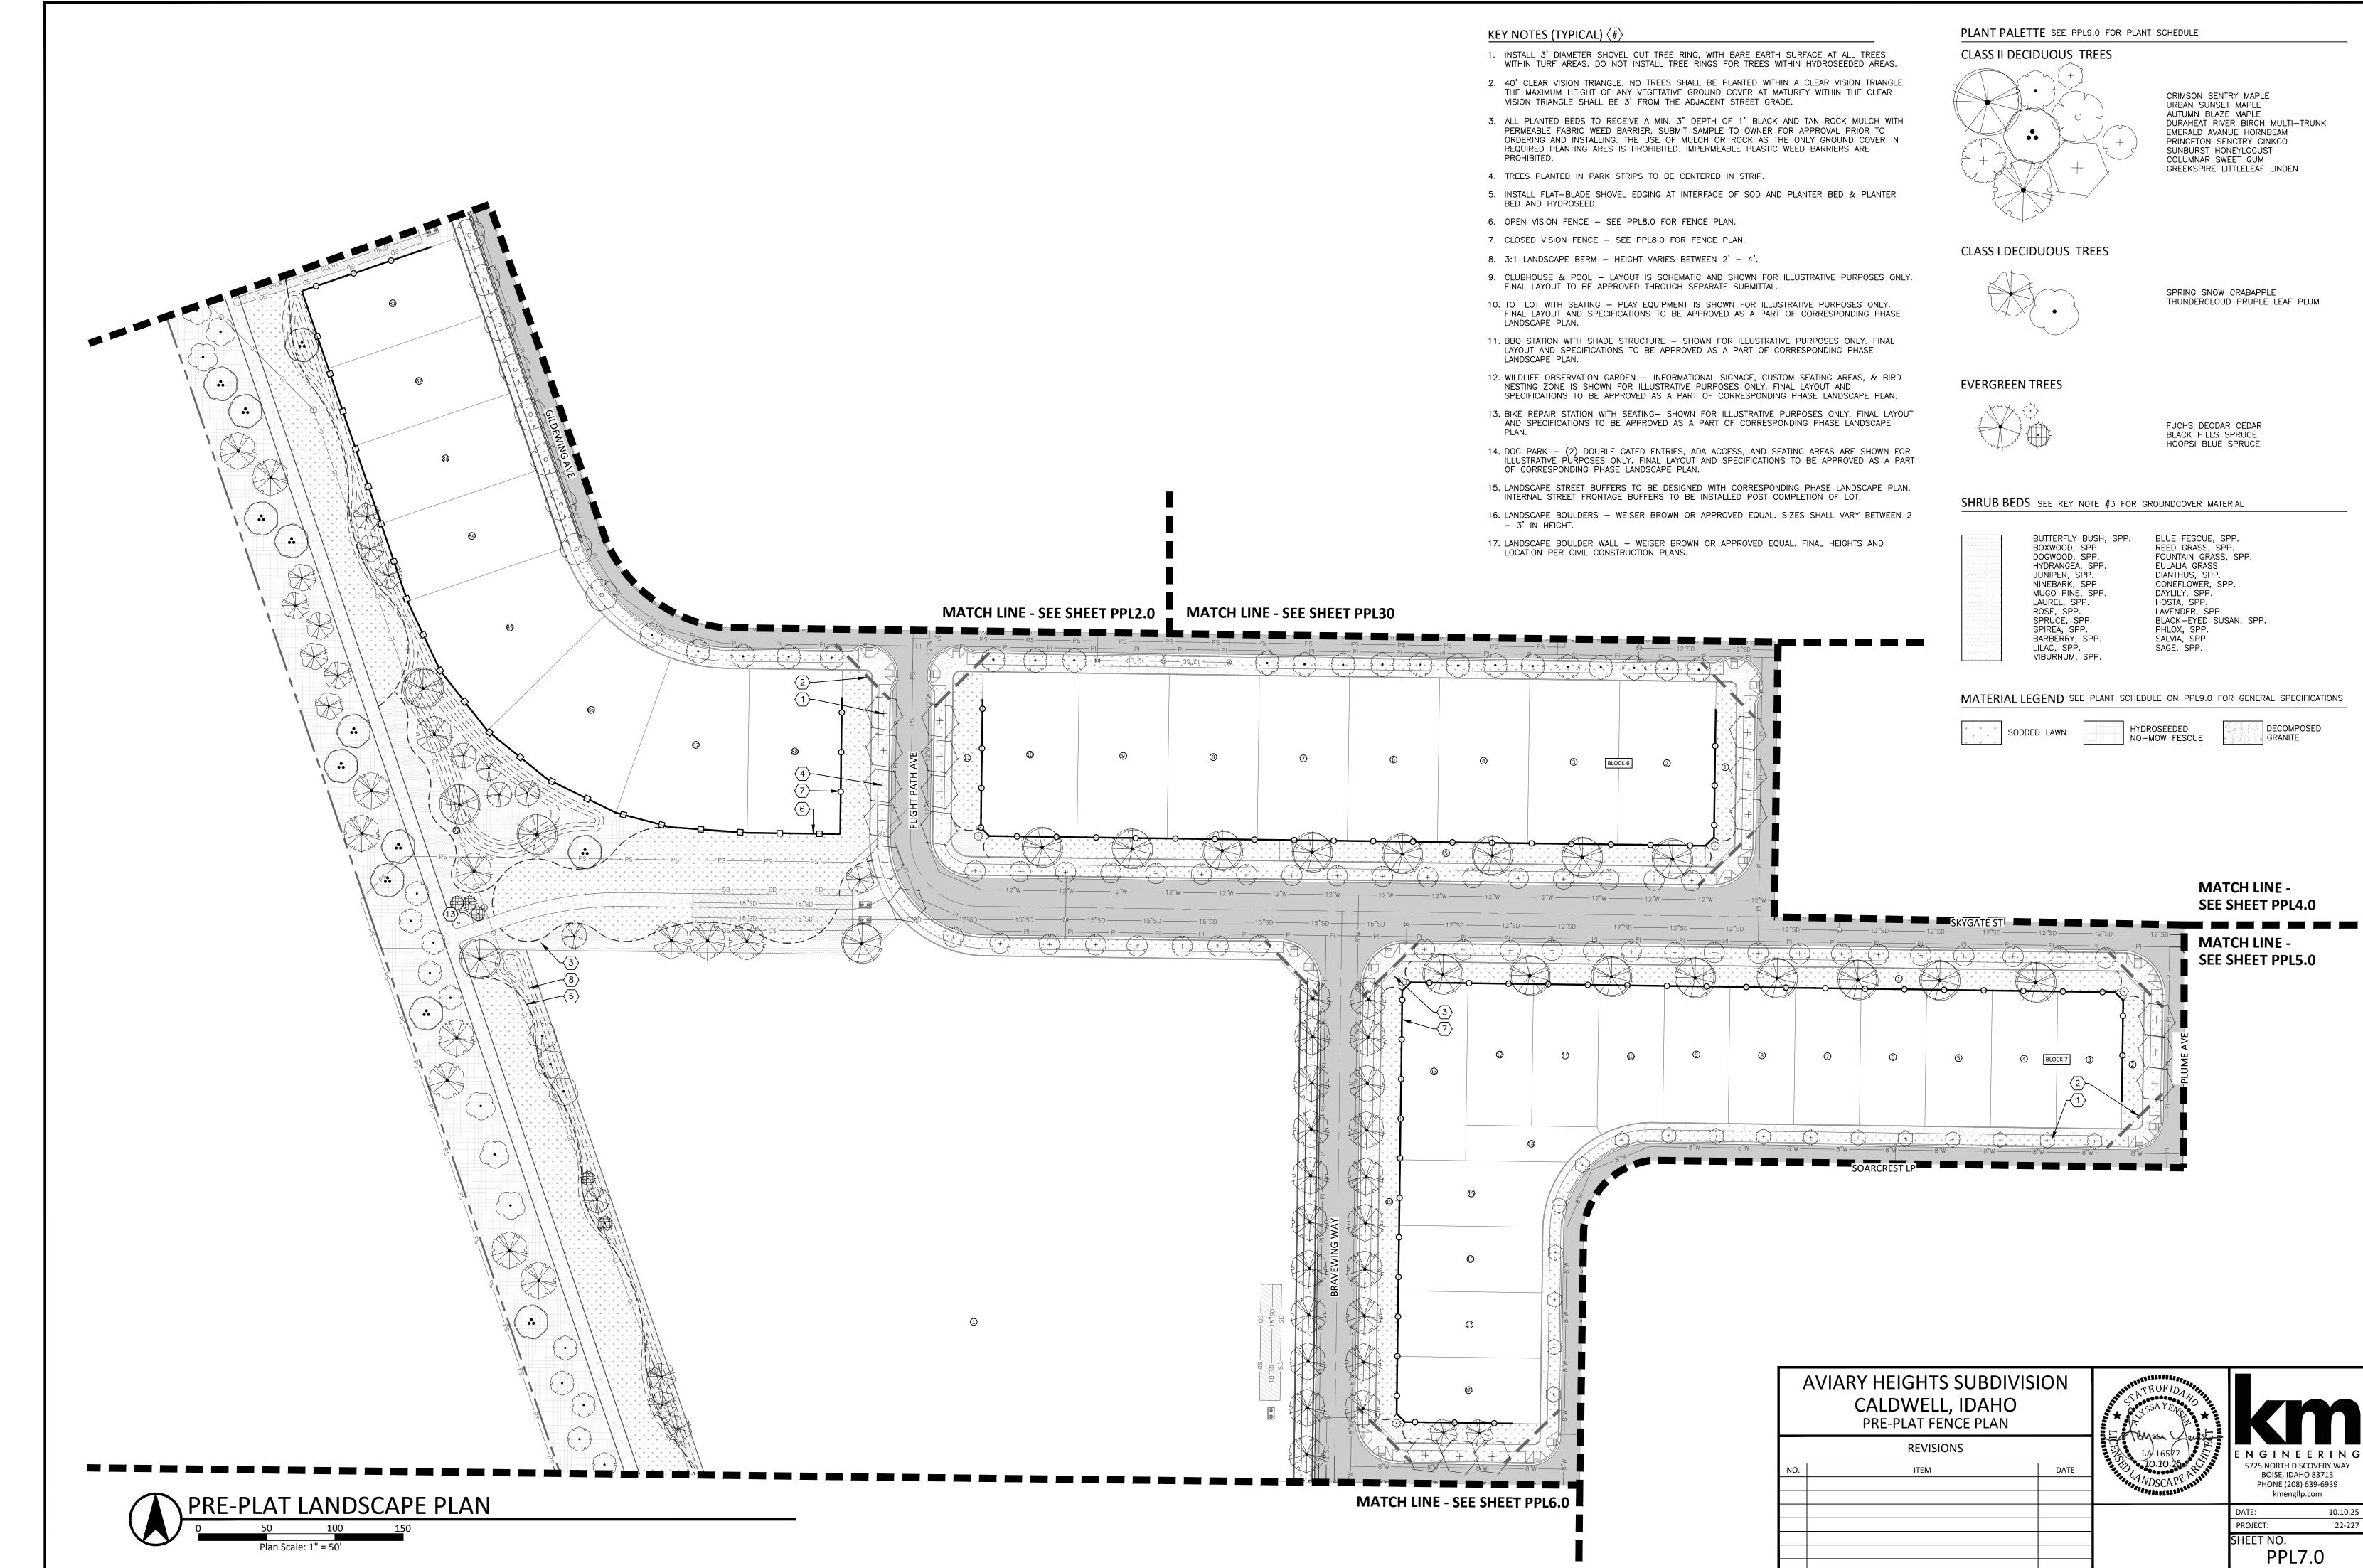10.10.25

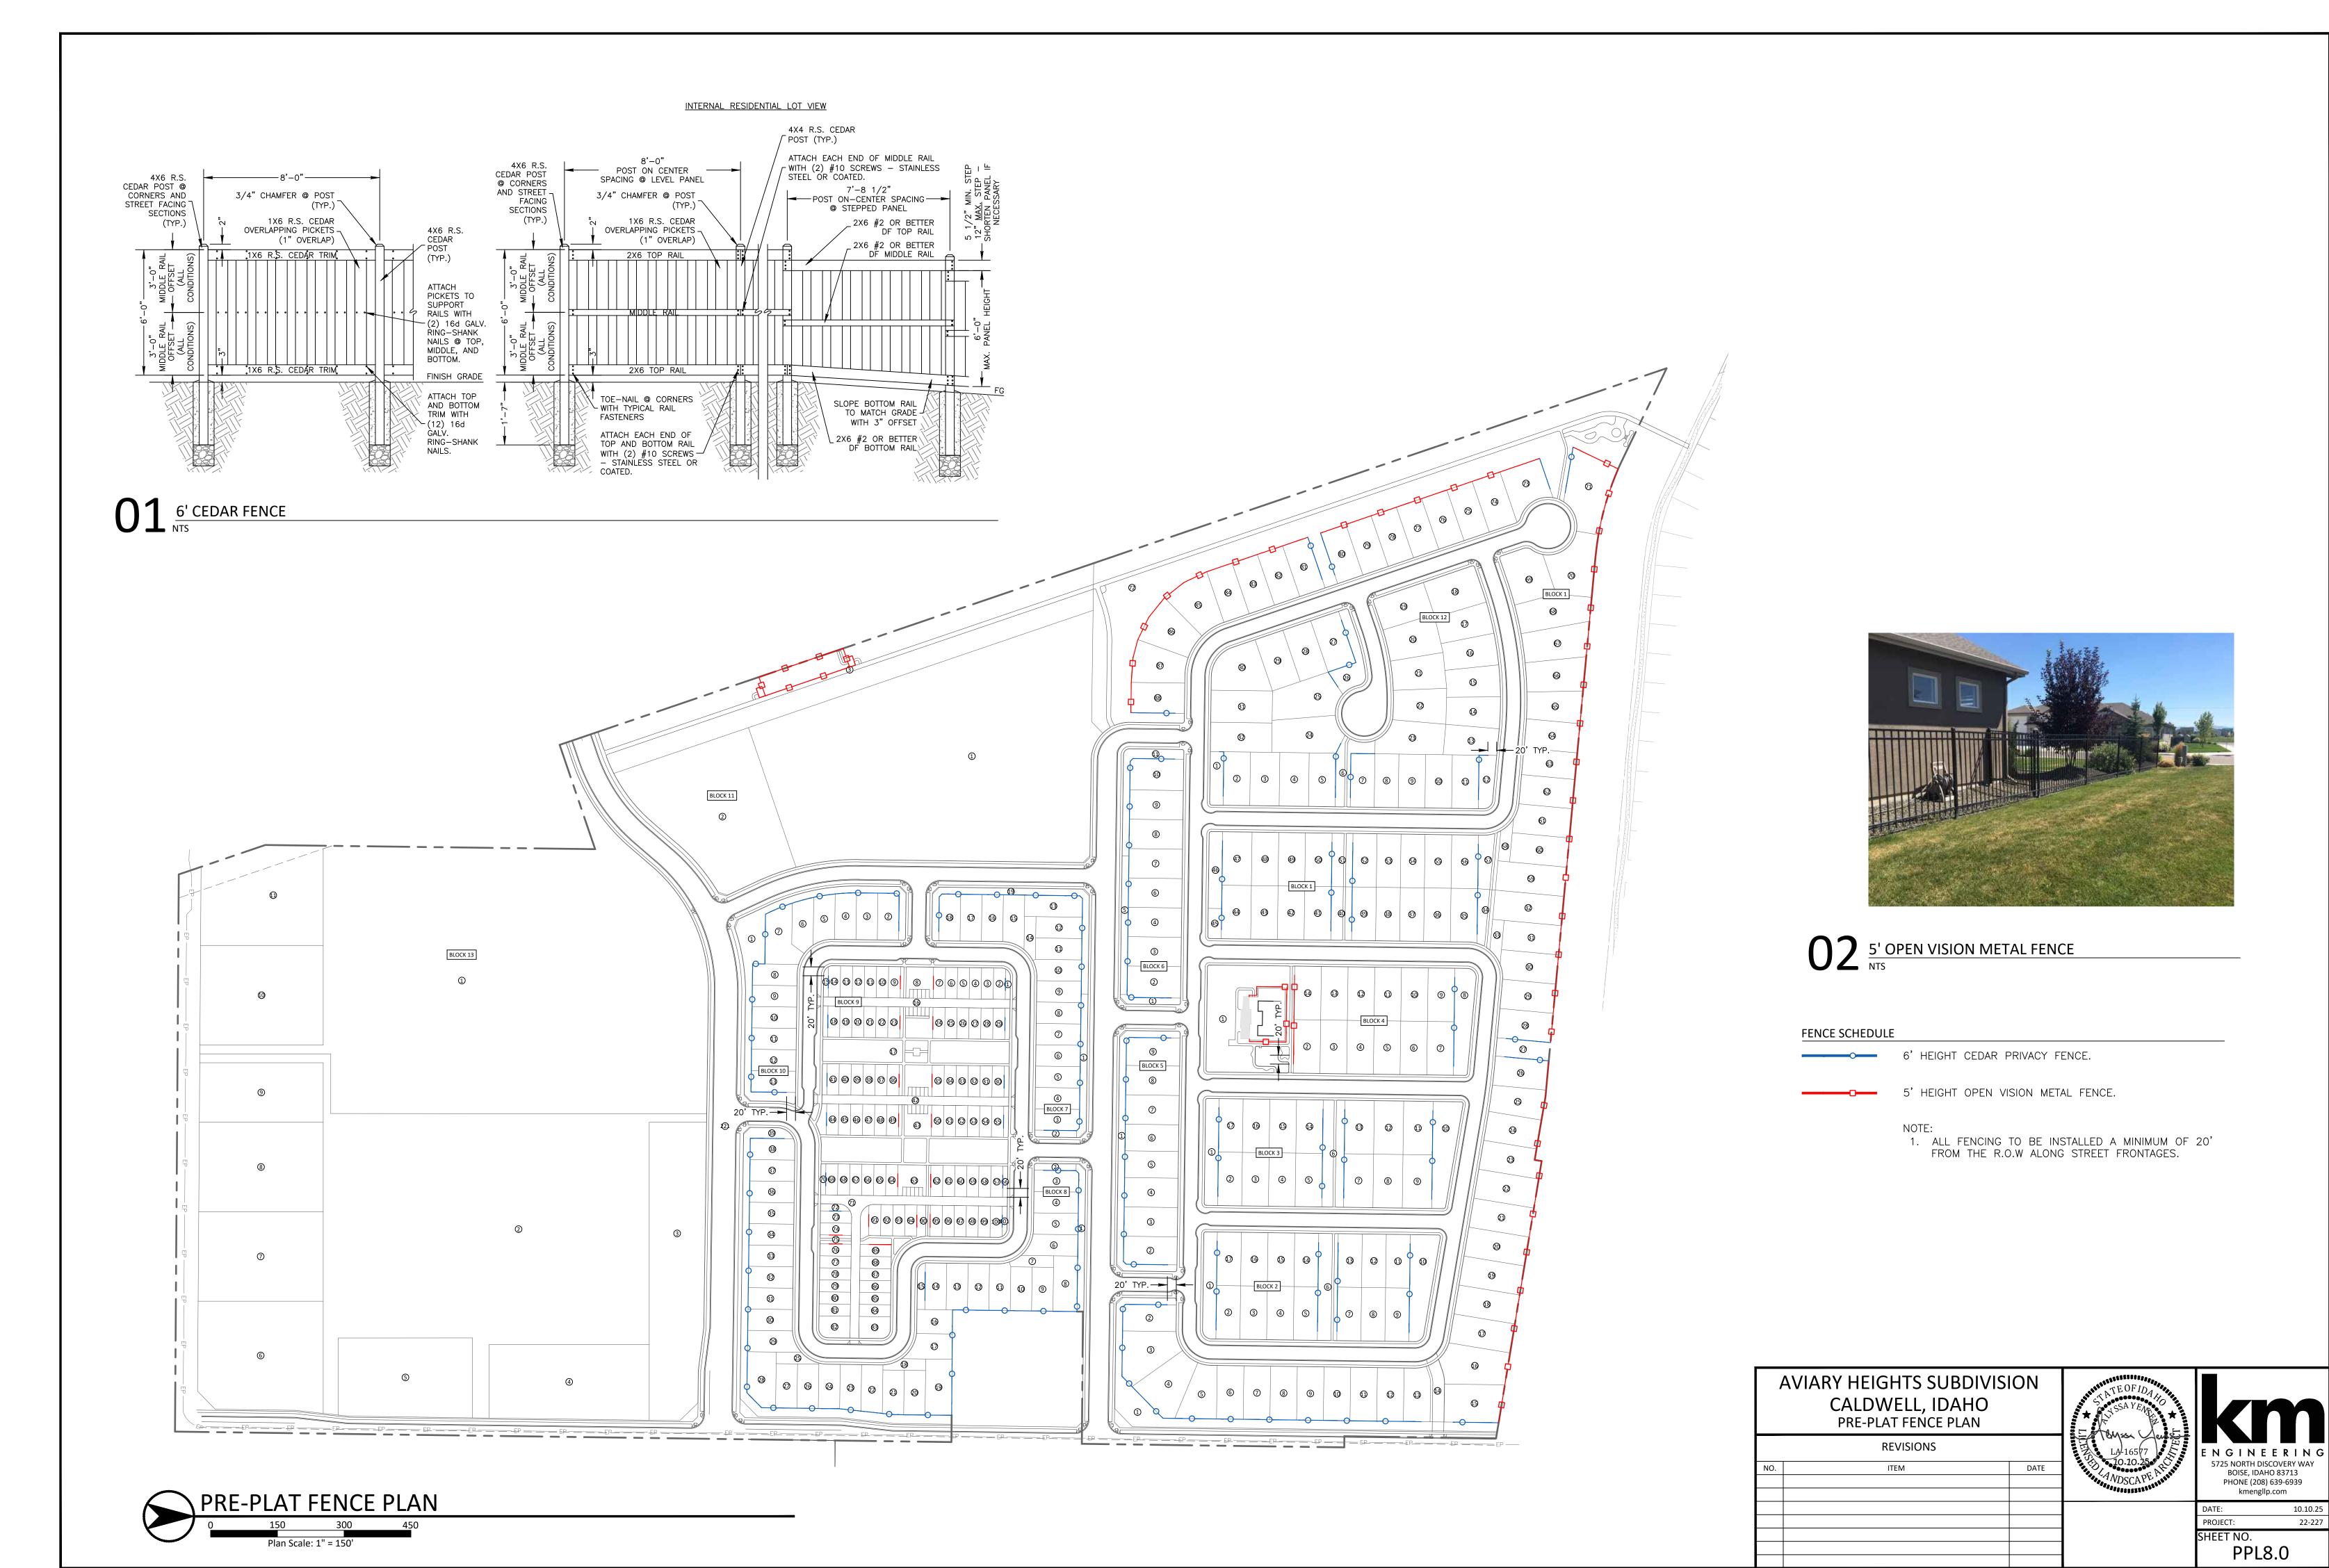O2 SOARING HEIGHTS DR. BUFFER SECTION NTS

FINAL LAYOUT AND SPECIFICATIONS TO BE APPROVED AS A PART OF CORRESPONDING PHASE LANDSCAPE PLAN.

SOARING HEIGHTS DR. LAWN SOARING HEIGHTS DR. LAWN SOARING HEIGHTS DR. LAWN WALKWAY 15' LANDSCAPE BUFFER-

1. LANDSCAPING IS SCHEMATIC —
FINAL LAYOUT AND SPECIFICATIONS TO BE APPROVED AS A PART OF CORRESPONDING PHASE LANDSCAPE PLAN.

MIDLAND BLVD BERM BUFFER SECTION

1. LANDSCAPING IS SCHEMATIC -

–20' LANDSCAPE BUFFER –

PLANT SCHEDULE

SYMBOL	QTY	BOTANICAL / COMMON NAME	SIZE	MATURE HXW	CLASS
DECIDUOUS	S TREES				
+	173	ACER PLATANOIDES 'CRIMSON SENTRY' CRIMSON SENTRY MAPLE	2" CAL. B&B	25'X15'	CLASS II
	107	ACER TRUNCATUM X PLATANOIDES 'JFS-KW187' URBAN SUNSET® MAPLE	2" CAL. B&B	35'X2Ø'	CLASS II
	67	ACER X FREEMANII 'JEFFSRED' AUTUMN BLAZE MAPLE	2" CAL. B&B	50°X30°	CLASS II
	36	BETULA NIGRA 'DURAHEAT' DURAHEAT RIVER BIRCH MULI-TRUNK	2" CAL. B&B CLUMP	35'X3Ø'	CLASS II
+	133	CARPINUS BETULUS 'JFS-KW1CB' EMERALD AVENUE HORNBEAM	2" CAL. B&B	40'X30'	CLASS II
£ + 3	1Ø1	GINKGO BILOBA 'PNI 272Ø' PRINCETON SENTRY® GINKGO MALE VARIETY ONLY	2" CAL. B&B	45'X2Ø'	CLASS II
	115	GLEDITSIA TRIACANTHOS INERMIS 'SUNCOLE' SUNBURST HONEYLOCUST	2" CAL. B&B	4Ø'X25'	CLASS II
+	153	LIQUIDAMBAR STYRACIFLUA 'SLENDER SILHOUETTE' COLUMNAR SWEET GUM	2" CAL. B&B	25'X15'	CLASS II
	45	MALUS "SPRING SNOW" SPRING SNOW CRABAPPLE	2" CAL. B&B	25'X2Ø'	CLASS I
	67	PRUNUS CERASIFERA 'THUNDERCLOUD' THUNDERCLOUD PURPLE LEAF PLUM	2" CAL. B&B	20'X20'	CLASS I
	86	TILIA CORDATA 'GREENSPIRE' GREENSPIRE LITTLELEAF LINDEN	2" CAL. B&B	45'X35'	CLASS II
EVERGREEN	N TREES				
++	25	CEDRUS DEODARA 'KARL FUCHS' FUCHS DEODAR CEDAR	6'-8' B&B	15'X8'	EVERGREEN
	34	PICEA GLAUCA 'DENSATA' BLACK HILLS WHITE SPRUCE	6'-8' B&B	55'X25'	EVERGREEN
	39	PICEA PUNGENS 'HOOPSII' HOOPSI BLUE SPRUCE	6'-8' B&B	35'X15'	EVERGREEN
SYMBOL	QTY	BOTANICAL / COMMON NAME	CONT		
SOD/SEED	147,77Ø SF	NO MOW LAWN SEED MIX HIGH COUNTRY GARDENS, PRAIRIE NURSERY OR APPROVED EQUAL SPECIALLY BLENDED MIX OF (6) DIFFERENT DWARF FINE FESCUE GRASS VARIETIES INSTALL AT MIN. OF 5 LBS PER 1000 SQUARE FEET	SEED		
\(\psi\) \(\	574,187 SF	TURF SOD RHIZOMATOUS RHIZOMATOUS TALL FESCUE	SOD		
<u>OTHER</u>	4,190 SF	DECOMPOSED GRANITE TBD	- MIN. 2-GAL SHRUBS		
	136,981 SF	SHRUB BEDS	OR 10" HEIGHT		
NOTE:		SEE PLANT PALETTE FOR SUGGESTED SHRUB VARIETIES	AND/OR SPREAD		
1. SPECI	FICATIONS ARE	SUBJECT TO CHANGE.			


## GENERAL LANDSCAPE NOTES


- 1. CONTRACTOR SHALL LOCATE AND IDENTIFY EXISTING UNDERGROUND AND OVERHEAD UTILITIES WITHIN CONTRACT WORK AREAS PRIOR TO CONSTRUCTION. CONTACT DIG LINE, INC. @ 1.800.342.1585. PROVIDE ADEQUATE MEANS OF PROTECTION OF UTILITIES AND SERVICES DESIGNATED TO REMAIN. REPAIR UTILITIES DAMAGED DURING SITE WORK OPERATIONS AT CONTRACTOR'S EXPENSE.
- 2. ALL PLANT MATERIAL SHALL CONFORM TO THE AMERICAN NURSERYMAN STANDARDS FOR TYPE AND SIZE SHOWN.
- 3. ALL TREE, TURF, PLANT MATERIAL, AND IRRIGATION PROPOSED WITHIN THE PLANTER STRIP BETWEEN BACK OF CURB AND SIDEWALK SHALL BE INSTALLED BY THE HOME BUILDER IN CONJUNCTION WITH THE INDIVIDUAL LOT DEVELOPMENT.
- 4. ALL TREES PLANTED IN THE PARK STRIP (BY BUILDER) TO BE CENTERED BETWEEN BACK OF CURB AND SIDEWALK AND ARE SUBJECT TO THE ACHD DEVELOPMENT AGREEMENT FOR LANDSCAPING.
- 5. FENCING WITHIN SUBDIVISION, ALONG SIDE AND REAR LOT LINES SHALL BE INSTALLED BY BUILDER/HOMEOWNER IN CONJUNCTION WITH INDIVIDUAL LOT DEVELOPMENT AND SHALL COMPLY WITH THE STANDARDS ESTABLISHED IN THE SUBDIVISION'S CC&RS.


## GENERAL IRRIGATION NOTES


- 1. ALL PLANT MATERIALS TO BE WATERED BY THE DEVELOPMENT OR SUBDIVISION PRESSURIZED IRRIGATION SYSTEM. IRRIGATION OF COMMON AREAS SHALL BE VIA THE SUBDIVISION'S PRESSURIZED IRRIGATION SYSTEM. IRRIGATION OF INDIVIDUAL LOTS AND LANDSCAPING ALONG THE FRONTAGE OF PRIVATE LOTS SHALL BE PRESSURIZED IRRIGATION WATER, AND THE RESPONSIBILITY OF THE INDIVIDUAL LOT OWNERS.
- 2. COVERAGE; THE IRRIGATION SYSTEM SHALL BE DESIGNED TO PROVIDE ONE HUNDRED PERCENT (100%) COVERAGE WITH HEAD TO HEAD SPACING OR TRIANGULAR SPACING AS APPROPRIATÉ.
- 3. MATCHED PRECIPITATION RATES: SPRINKLER HEADS SHALL HAVE MATCHED PRECIPITATION RATES WITHIN EACH CONTROL VALVE.
- 4. IRRIGATION DISTRICTS: SPRINKLER HEADS IRRIGATING LAWN OR OTHER HIGH WATER DEMAND AREAS SHALL BE CIRCUITED SO THAT THEY ARE ON THE SEPARATE ZONE OR DISTRICT FROM THOSE IRRIGATING TREES, SHRUBS, OR OTHER REDUCED WATER DEMAND AREAS.
- 5. OVERSPRAY: SPRINKLER HEADS SHALL BE ADJUSTED TO REDUCE OVERSPRAY ONTO IMPERVIOUS SURFACES SUCH AS STREETS, SIDEWALKS, DRIVEWAYS, AND PARKING


AVIARY HEIGHTS SUBDIVISI CALDWELL, IDAHO PRE-PLAT NOTES & DETAILS	SSAYEAR S	km			
REVISIONS		LA 16577	ENGINE	ERING	
ITEM	DATE	10.10.25 RECTAIN	5725 NORTH DIS BOISE, IDAH PHONE (208) kmenglip	O 83713 639-6939	
			DATE:	10.10.25	
			PROJECT:	22-227	

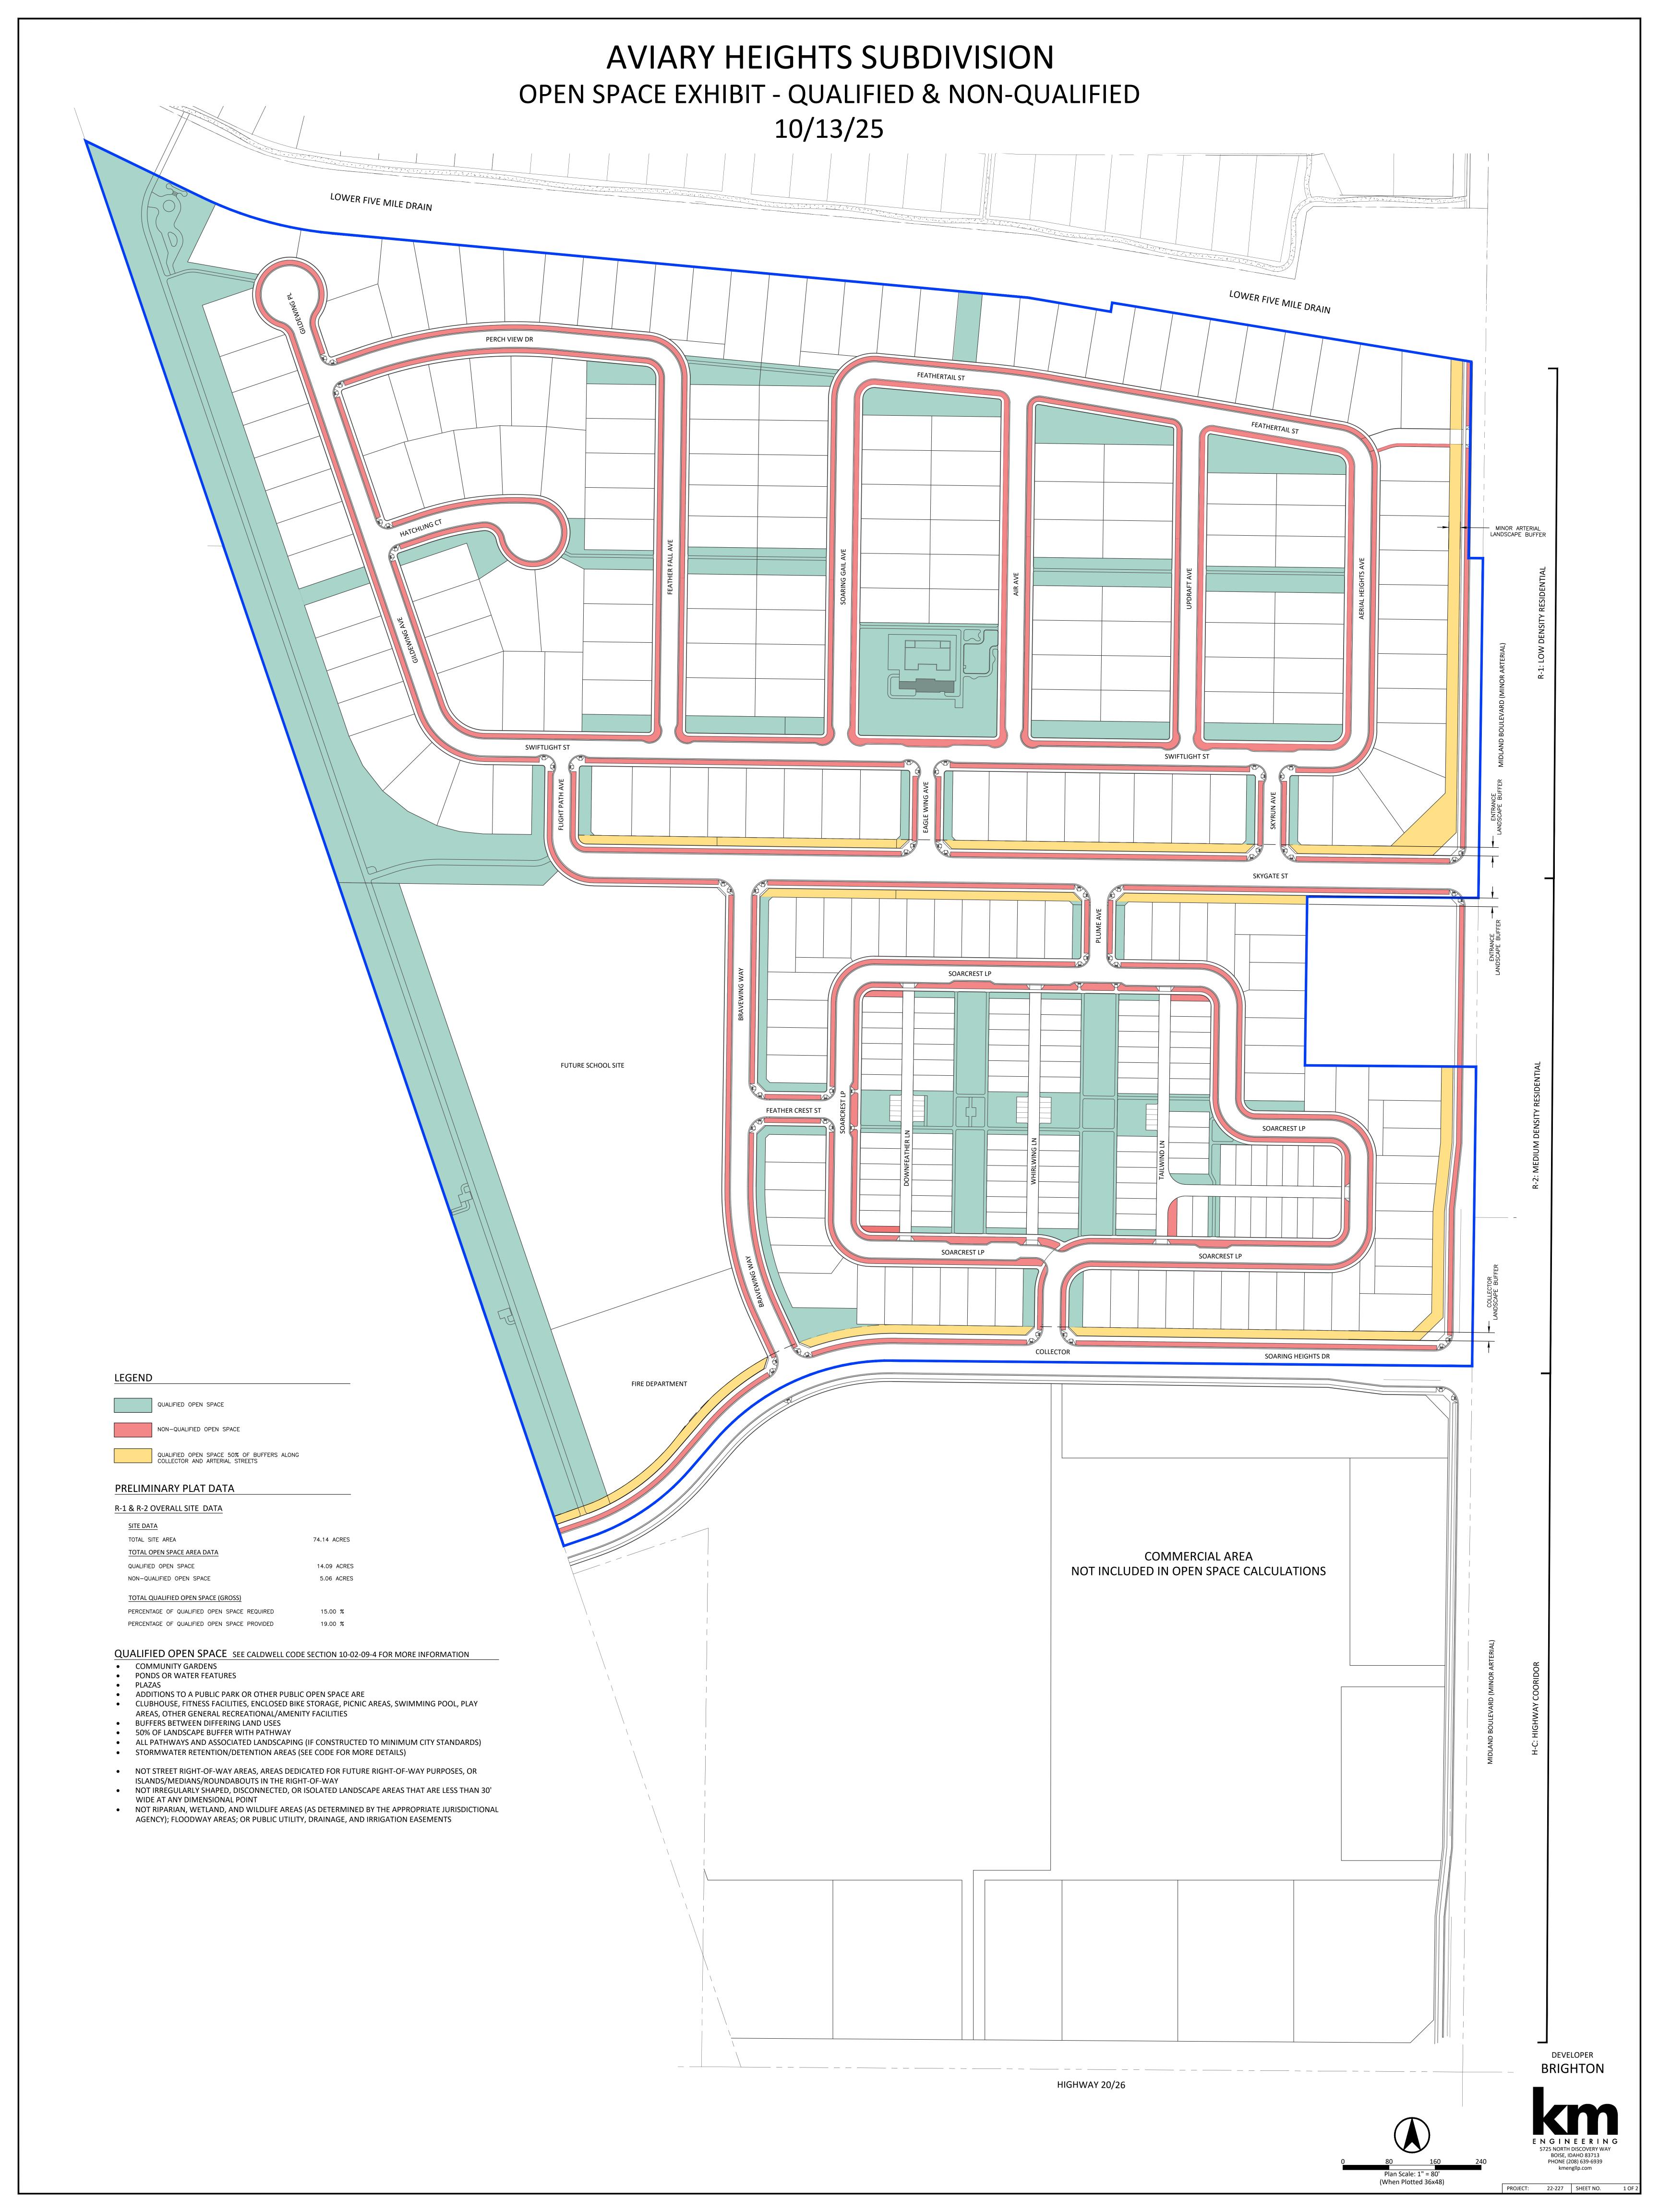

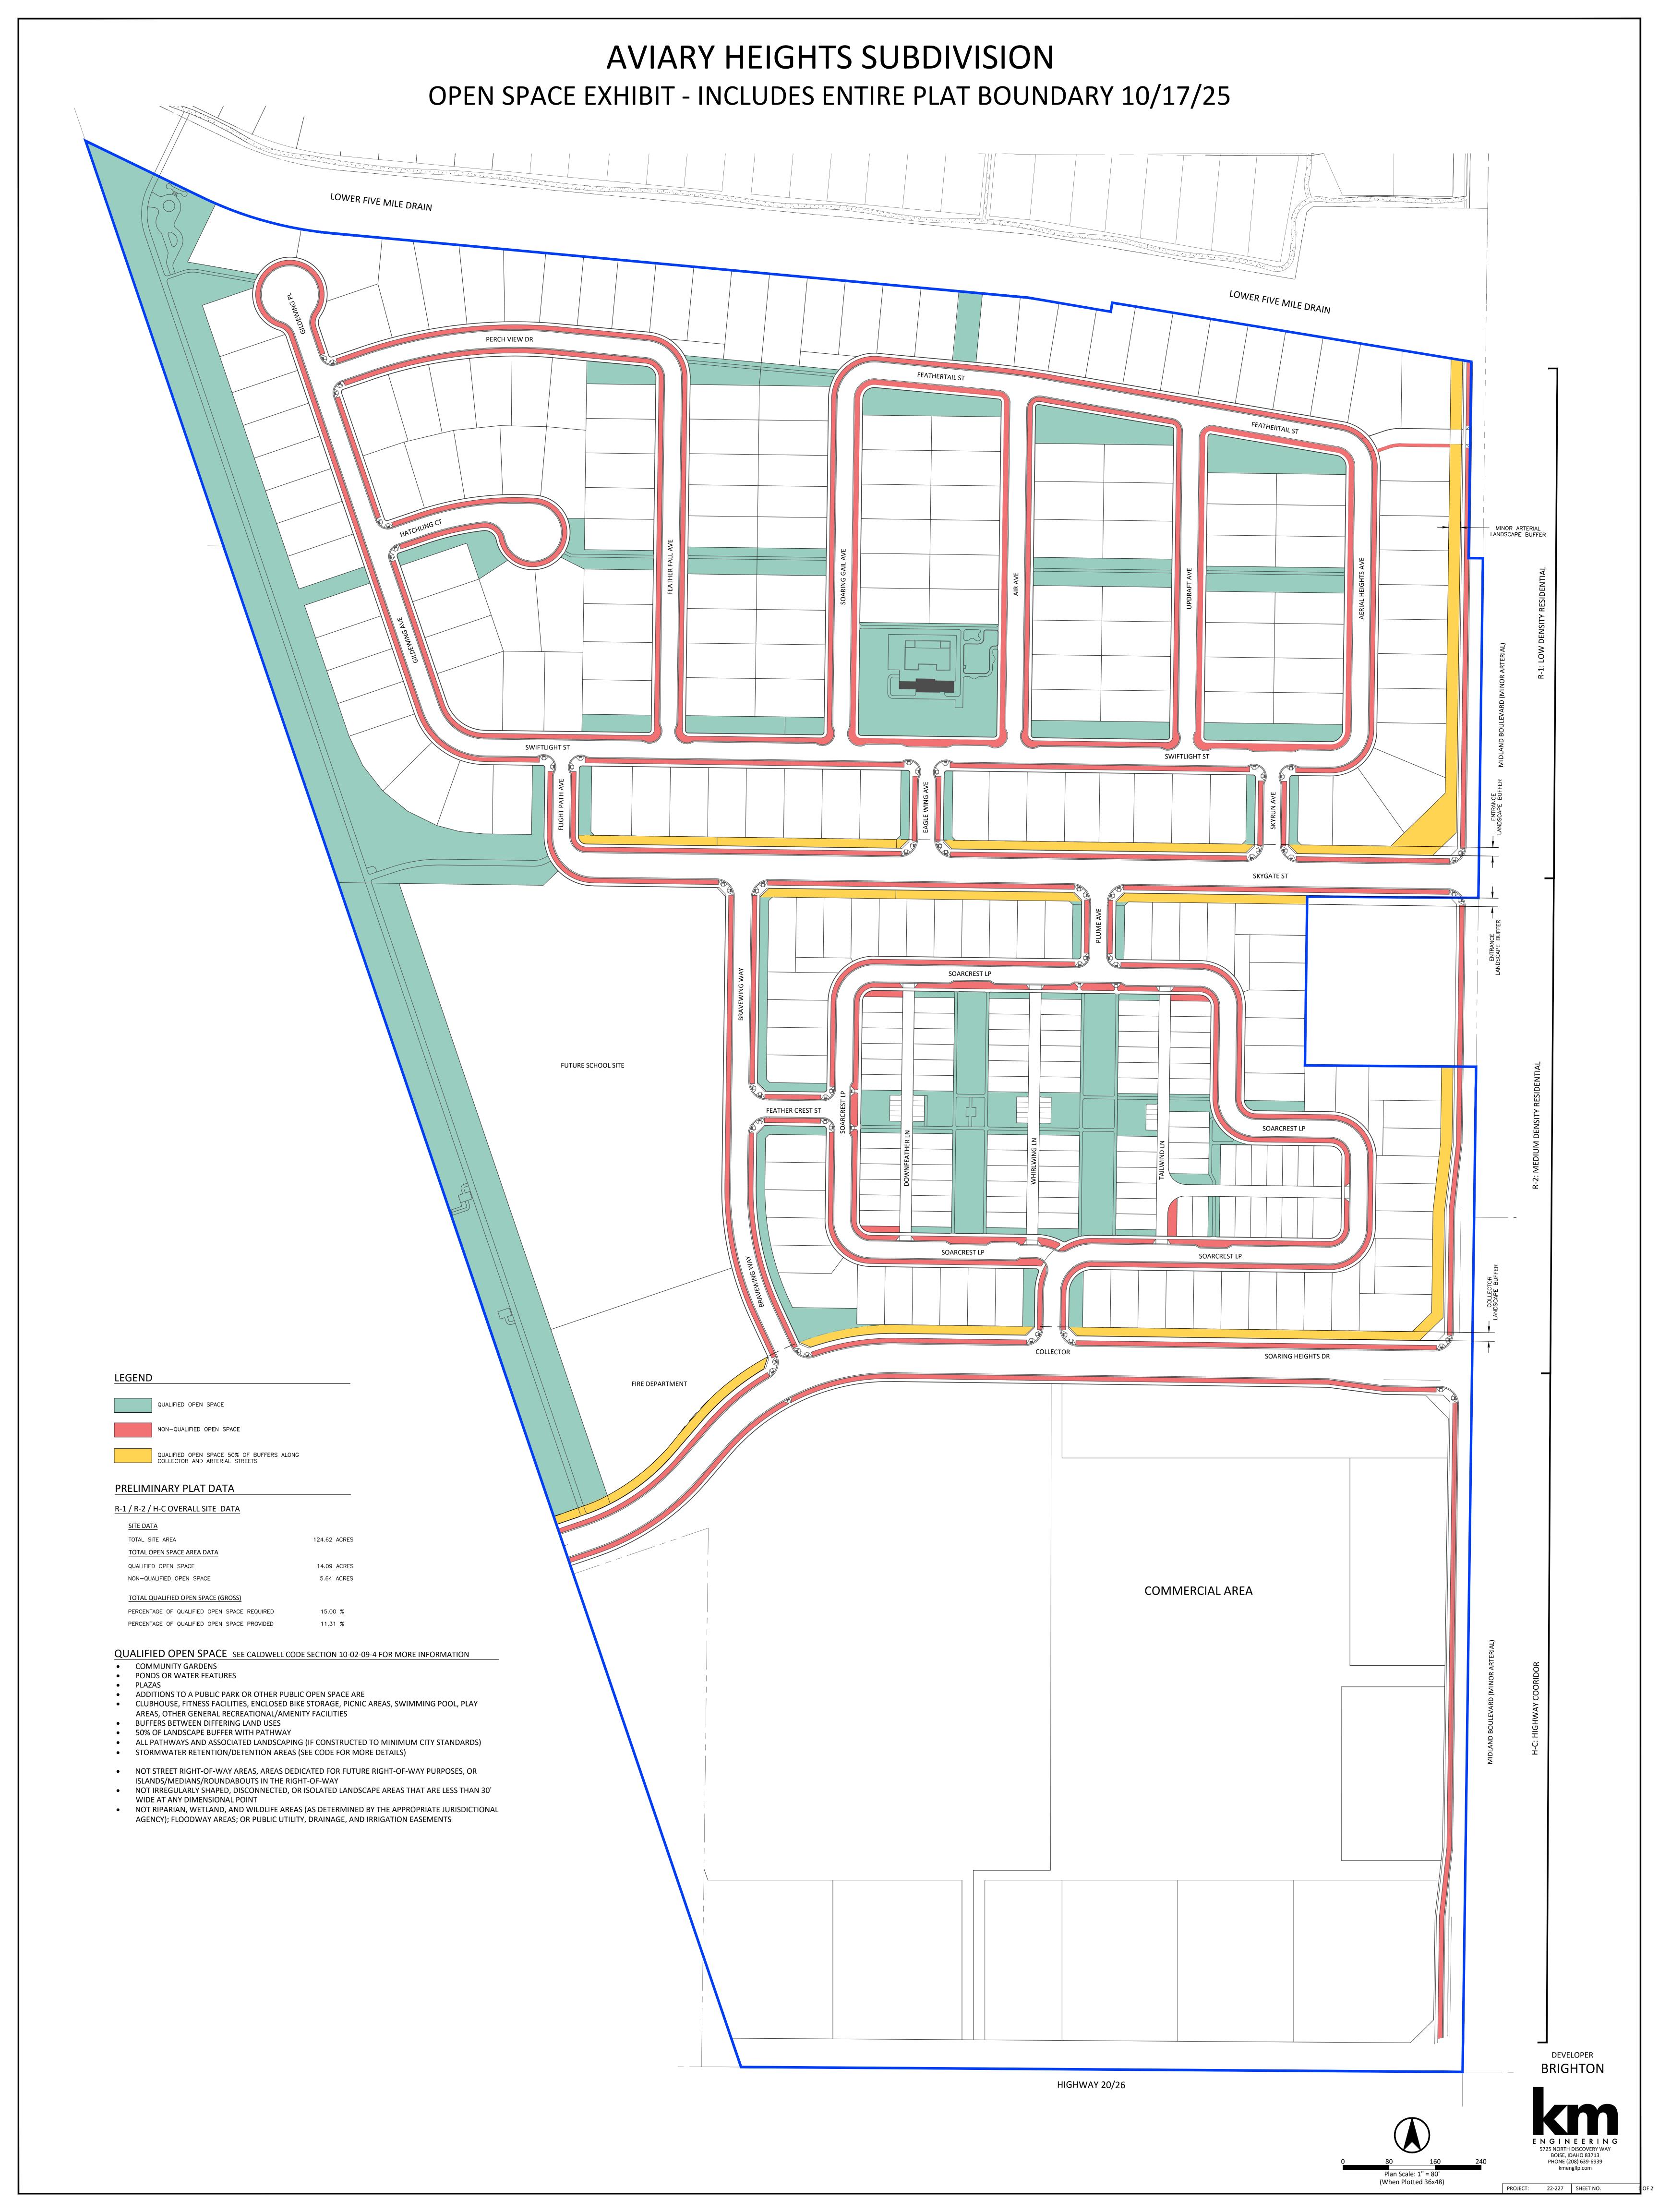

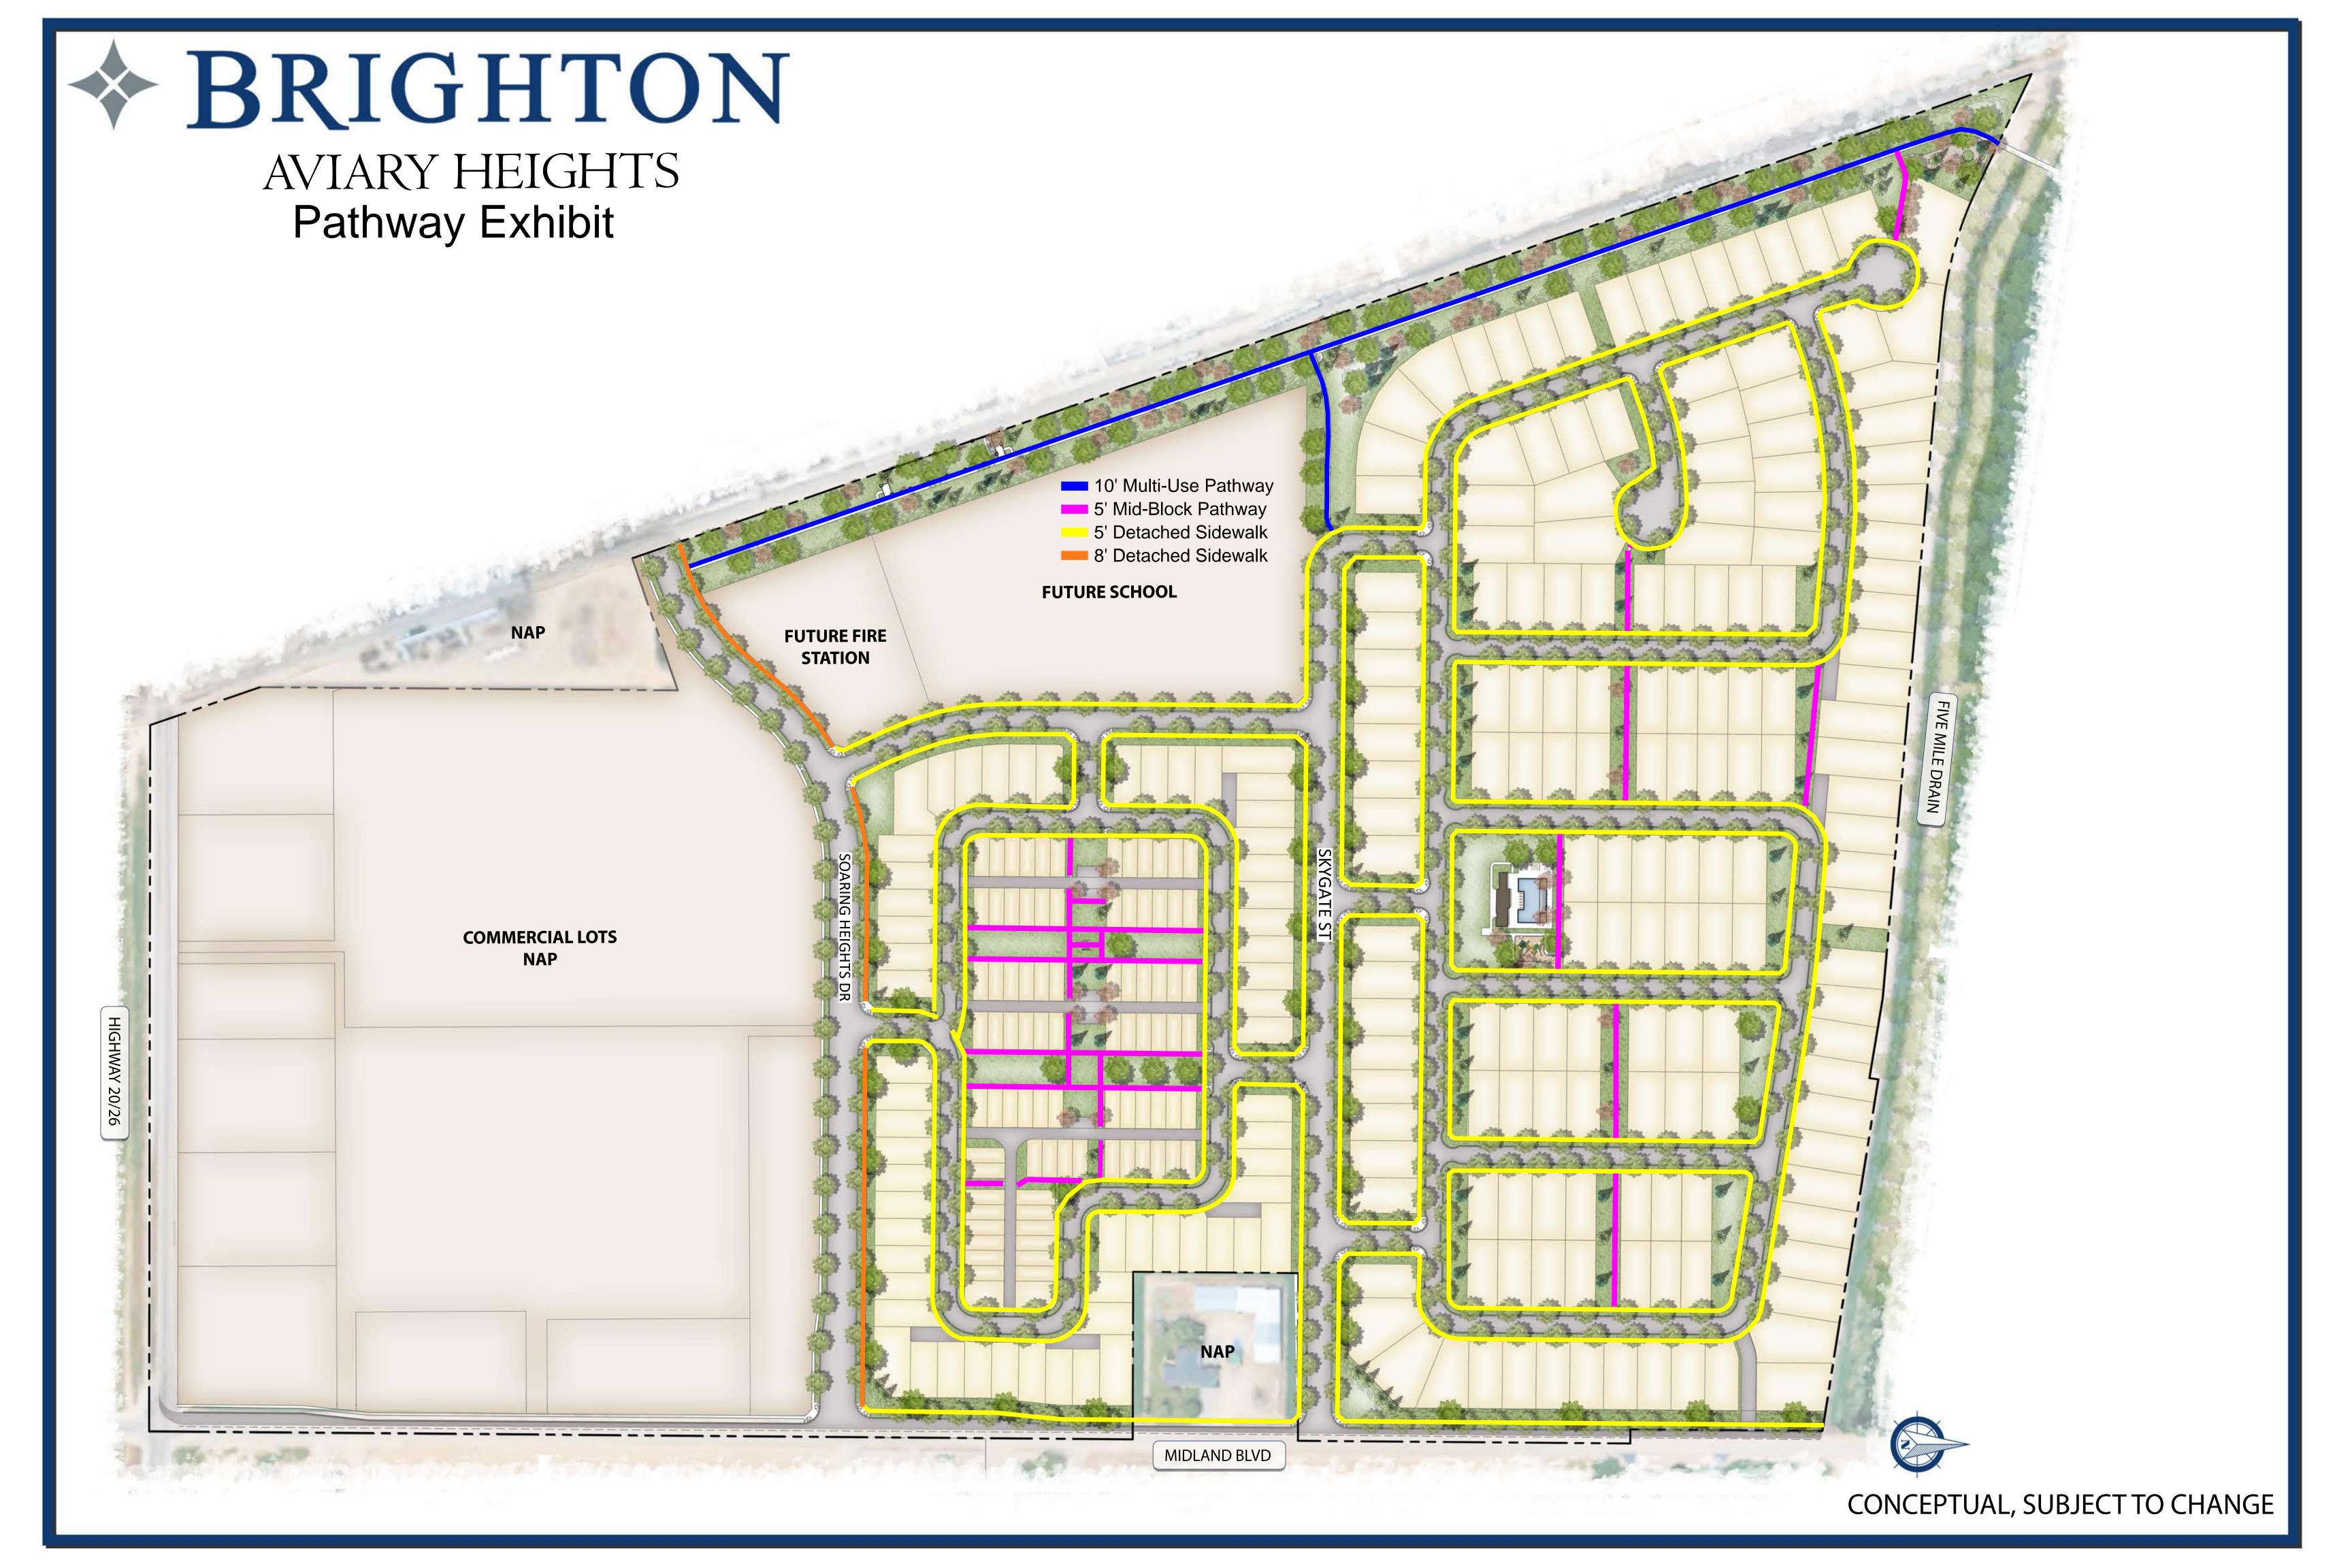


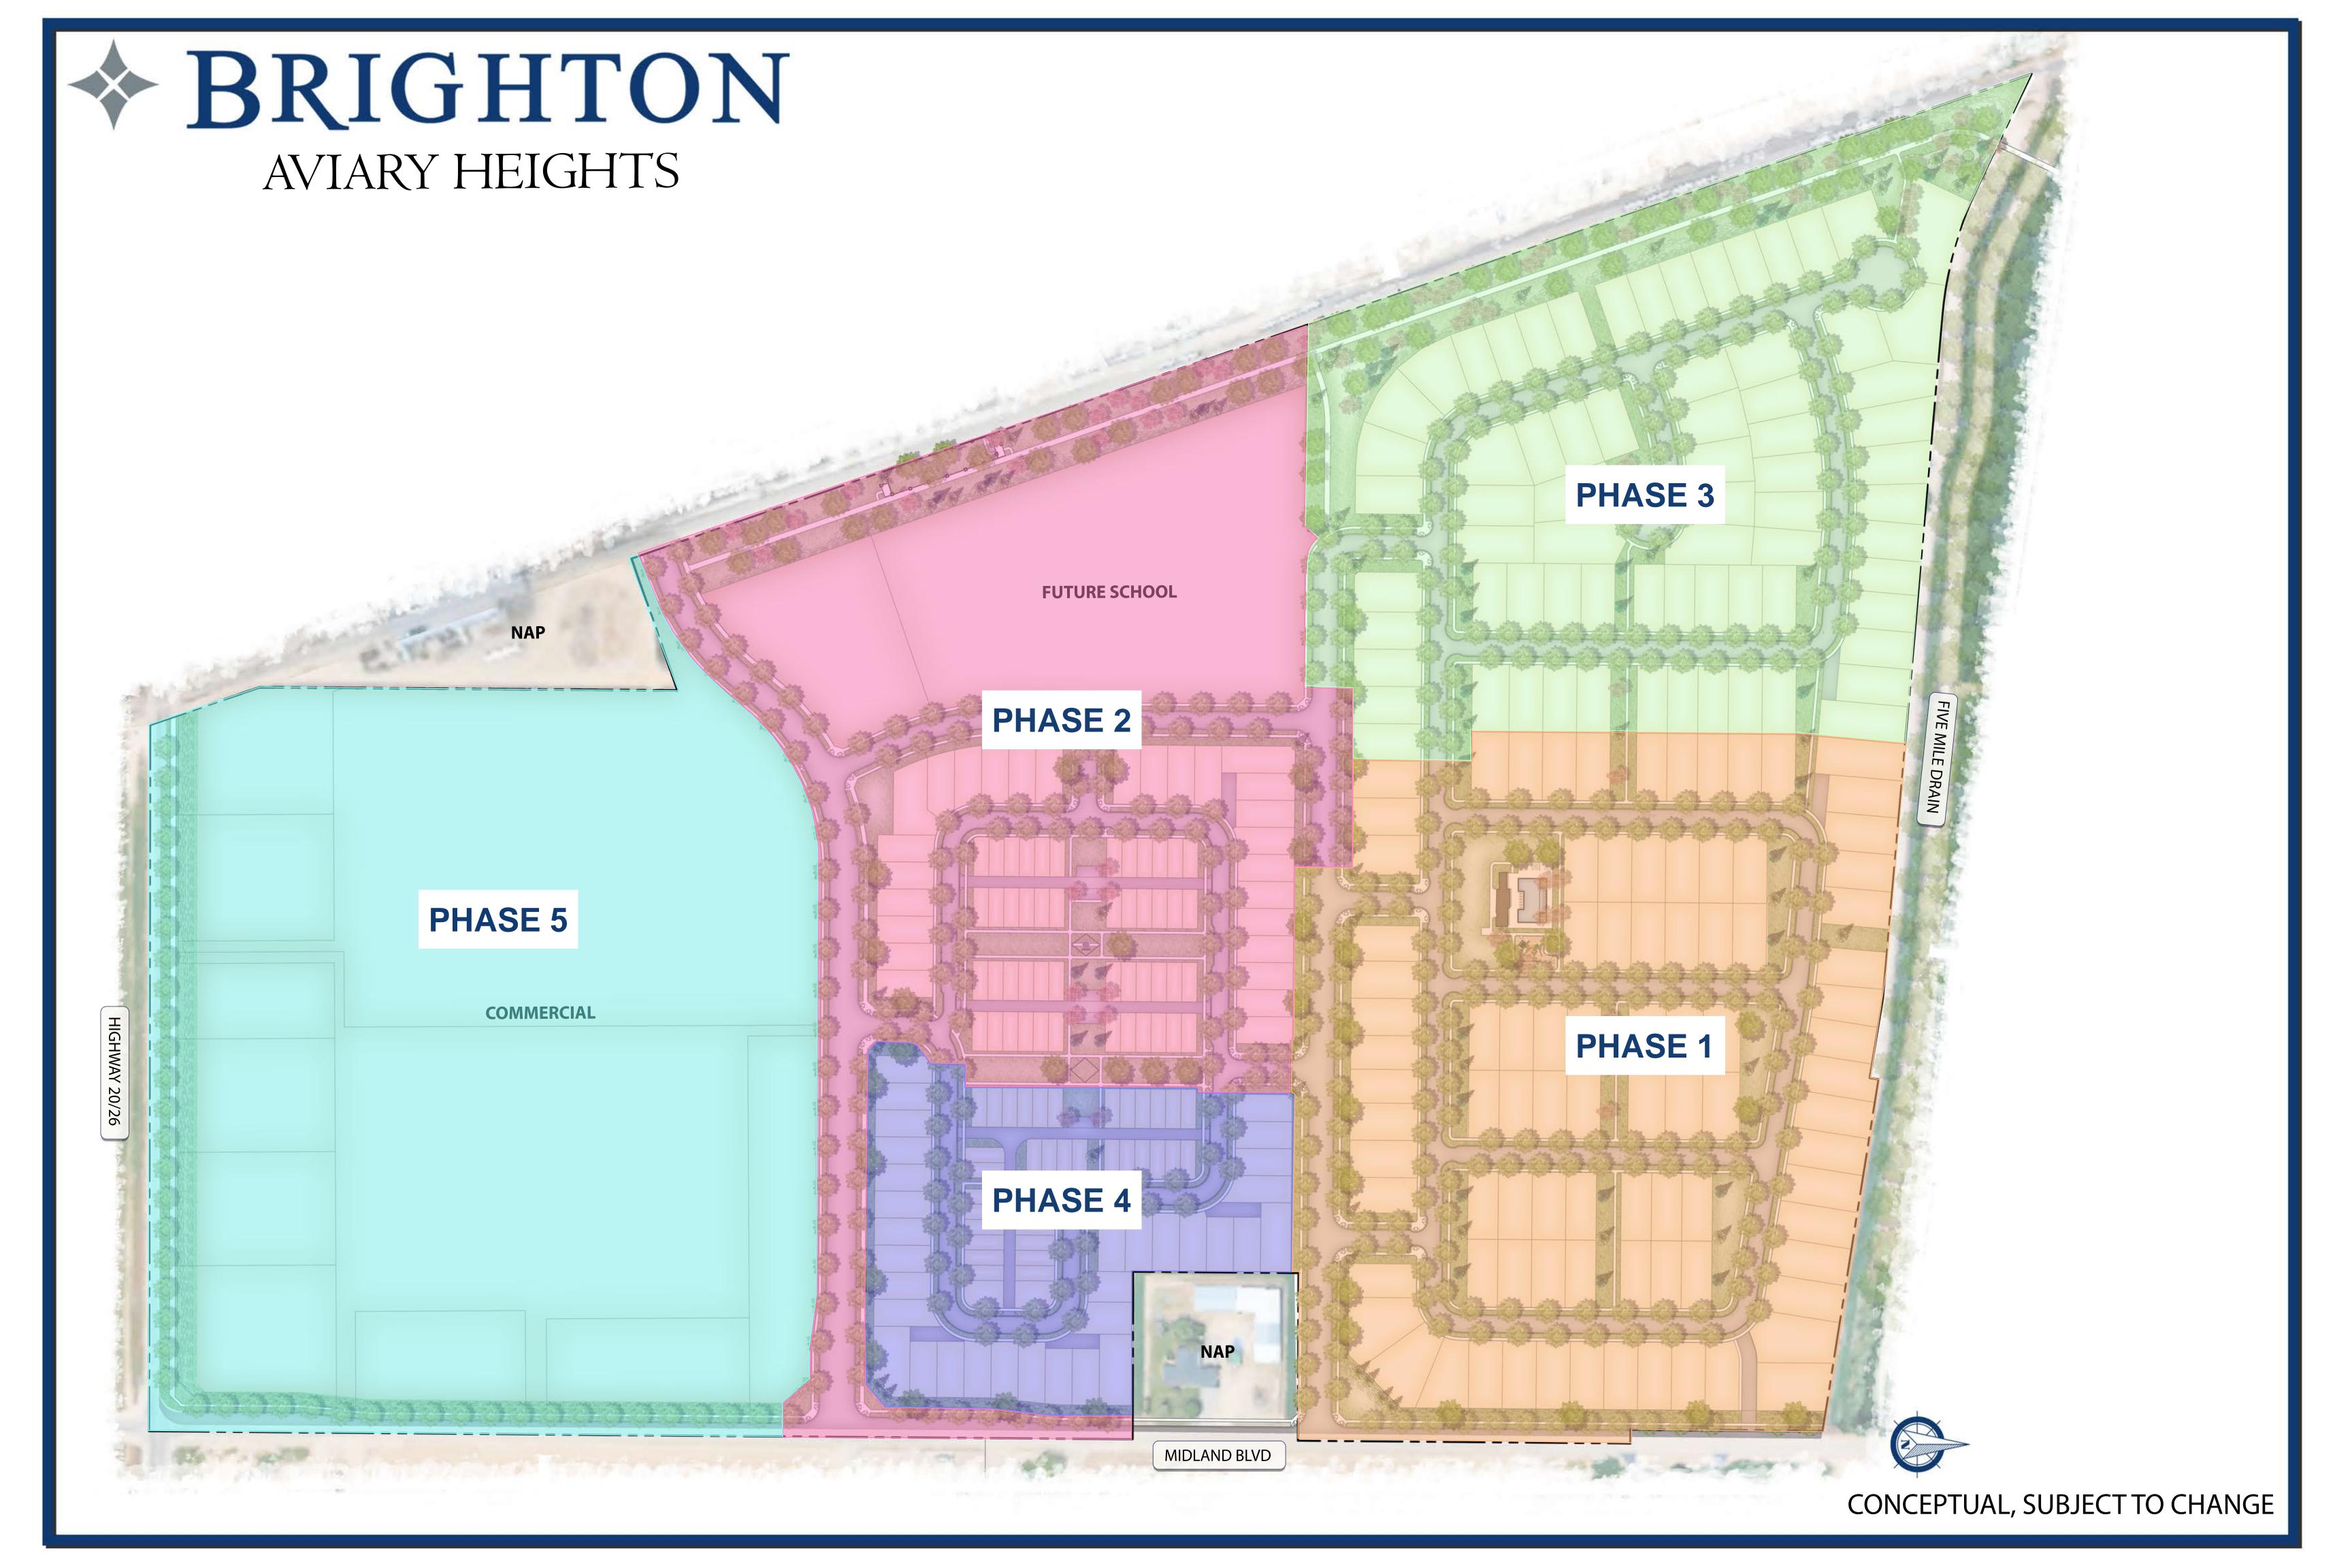

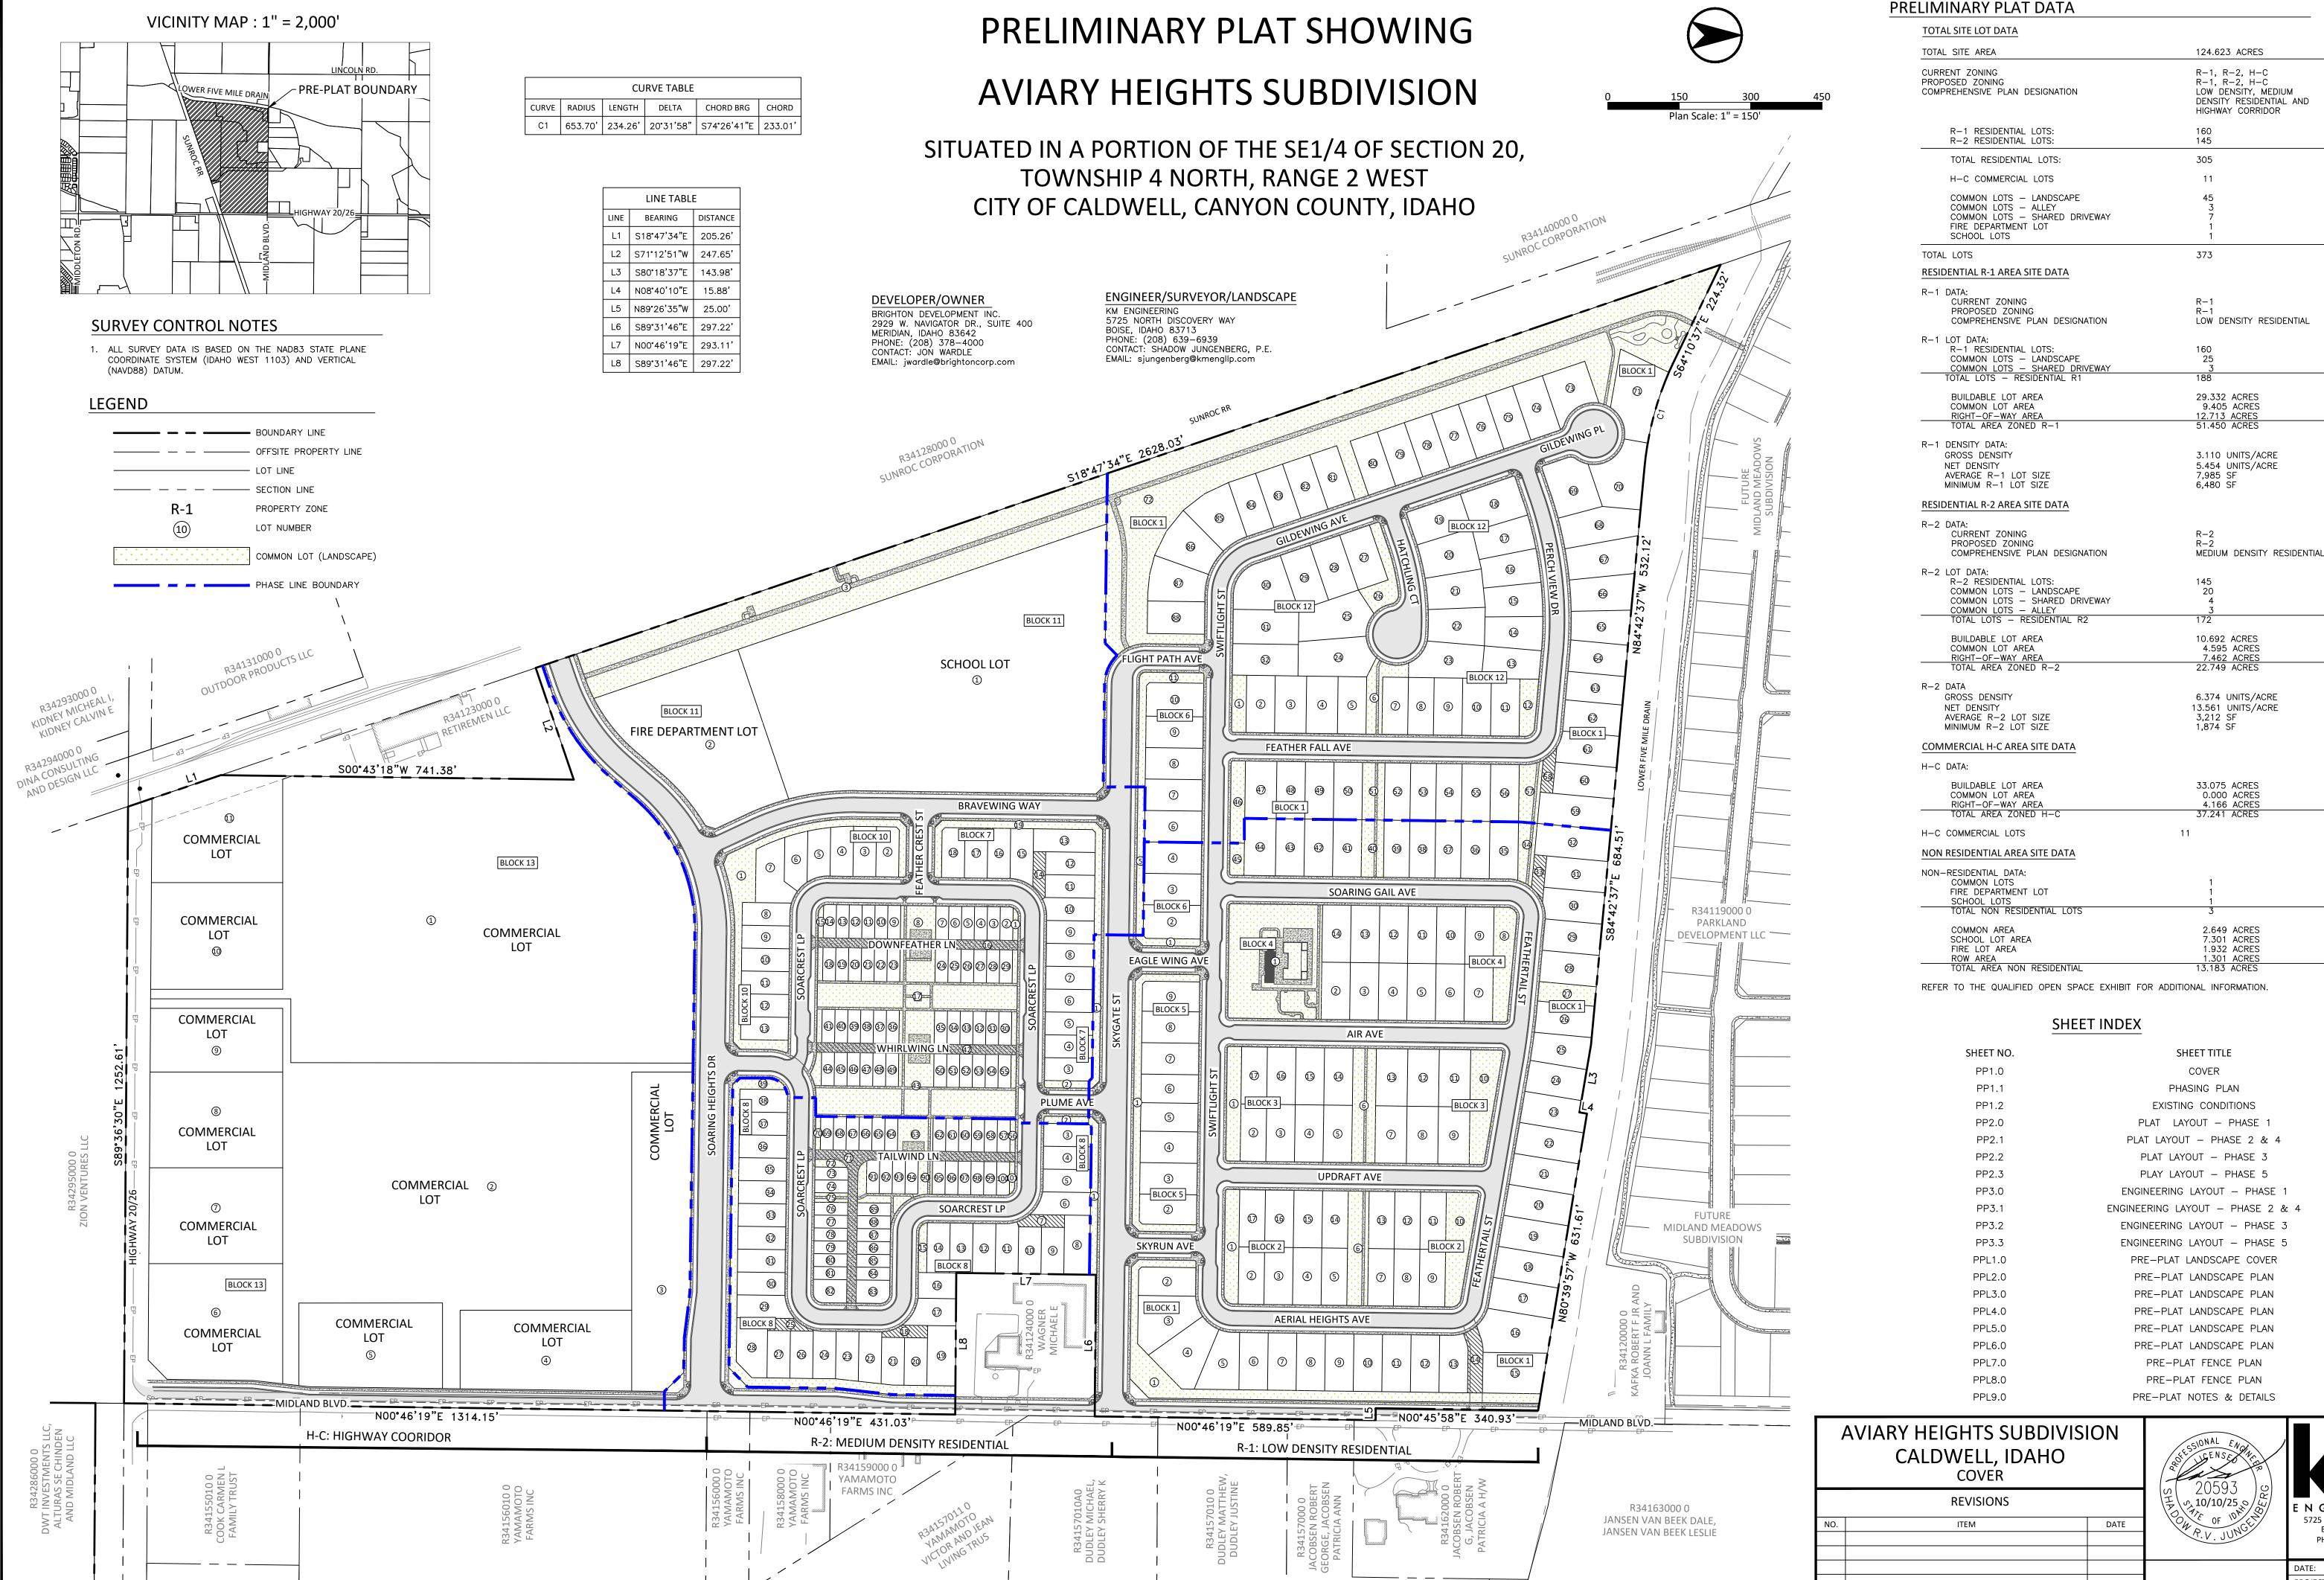

5725 NORTH DISCOVERY WAY BOISE, IDAHO 83713 PHONE (208) 639-6939 kmengllp.com

PROJECT: SHEET NO. PP1.0

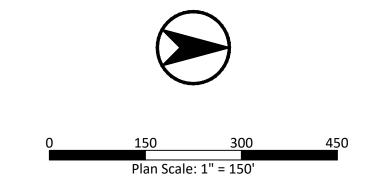

# PROJECT SUMMARY

PHASE 1 (R-1 ZONING):

SINGLE FAMILY RESIDENTIAL: 89 LOTS
 COMMON LOTS: 19 LOTS
 TOTAL LOTS: 108 LOTS

PHASE 2 (R-2 ZONING):

SINGLE FAMILY RESIDENTIAL: 75 LOTS
 COMMON LOTS: 14 LOTS
 FIRE STATION LOT: 1 LOT
 SCHOOL LOT: 1 LOT
 TOTAL LOTS: 91 LOTS

PHASE 3 (R-1 ZONING):

SINGLE FAMILY RESIDENTIAL: 71 LOTS
 COMMON LOTS: 10 LOTS
 TOTAL LOTS: 81 LOTS

PHASE 4 (R-2 ZONING):

SINGLE FAMILY RESIDENTIAL: 70 LOTS
 COMMON LOTS: 12 LOTS
 TOTAL LOTS: 82 LOTS

PHASE 5 (H-C ZONING):

- COMMERCIAL LOTS: 11 LOTS

TOTAL:

SINGLE FAMILY RESIDENTIAL: 305 LOTS
 COMMON LOTS: 55 LOTS
 FIRE STATION LOT: 1 LOT
 SCHOOL LOT: 1 LOT
 COMMERCIAL LOTS: 11 LOTS


TOTAL LOTS: 373 LOTS

AVIARY HEIGHTS SUBDIVISION CALDWELL, IDAHO PHASING PLAN

PHASING PLAN

REVISIONS

ITEM DATE

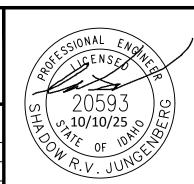

ENGINEERING
5725 NORTH DISCOVERY WAY
BOISE, IDAHO 83713
PHONE (208) 639-6939
kmengllp.com

DATE: 10.10.25
PROJECT: 22-227
SHEET NO.
PP1.1

KEYNOTES (TYPICAL)

1. EXISTING IRRIGATION DITCH TO #RELOCATED AND WILL EITHER BE PIPED OR REMAIN OPEN PER FUTURE ENGINEERING PLANS.

ACCESS TO ADJACENT PROPERTY SHALL BE MAINTAINED DURING CONSTRUCTION. RETAIN AND PROTECT OVERHEAD POWER

4. LOWER FIVE MILE DRAIN EASEMENT. DO NOT

5. GRAVEL ENTRANCE TO 'GOOD YEAR' SITE TO BE

RETAINED AND PROTECTED. ACCESS TO ADJACENT GOODYEAR PROPERTY SHALL BE MAINTAINED DURING CONSTRUCTION. 6. REMOVE GRAVITY IRRIGATION PIPE.

7. TREES TO BE REMOVED.

8. FRONTAGE POWER LINES ALONG MIDLAND BLVD TO BE RELOCATED IN FUTURE.

REMOVED AND DISPOSED OF OFFSITE PER STATE


10. REMOVE EXISTING GATED PIPE. 11. EXISTING POWER LINES ALONG HIGHWAY 20/26 TO

EXISTING CONDITIONS	
REVISIONS	
ITEM	DATE



F N G I N E E R I N G 5725 NORTH DISCOVERY WAY BOISE, IDAHO 83713 PHONE (208) 639-6939 kmengllp.com

PROJECT: SHEET NO. PP1.2

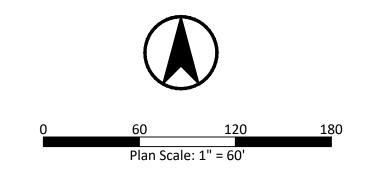

# PRELIMINARY PLAT NOTES


- FUTURE DEVELOPMENT SHALL BE CONSISTENT WITH THE MINIMUM DIMENSIONAL STANDARDS LISTED BY THE CITY OF CALDWELL STANDARDS FOR ZONING.
- 2. FRONT, REAR, AND SIDE YARD EASEMENT LOCATIONS AND WIDTHS TO BE DETERMINED WITH FINAL PLAT.
- 3. ANY RE-SUBDIVISION OF THIS PLAT SHALL COMPLY WITH THE MOST RECENTLY APPROVED SUBDIVISION STANDARDS OF THE CITY OF CALDWELL.
- 4. IRRIGATION WATER IS SUPPLIED FROM PIONEER IRRIGATION DISTRICT AND THE FRANKLIN DITCH COMPANY.
- 5. THIS DEVELOPMENT RECOGNIZES IDAHO CODE SECTION 22-4503, RIGHT TO FARM ACT, WHICH STATES 'NO AGRICULTURAL OPERATION, AGRICULTURAL FACILITY OR EXPANSION THEREOF SHALL BE OR BECOME A NUISANCE PRIVATE OR PUBLIC, BY ANY CHANGED CONDITIONS IN OR ABOUT THE SURROUNDING NON AGRICULTURAL ACTIVITIES AFTER IT HAS BEEN IN OPERATION FOR MORE THAN ONE (1) YEAR, WHEN THE OPERATION WAS NOT A NUISANCE AT THE TIME IT BEGAN OR WAS CONSTRUCTED. THE PROVISIONS OF THIS SECTION SHALL NOT APPLY WHENEVER A NUISANCE RESULTS FROM THE IMPROPER OR NEGLIGENT OPERATION OF ANY AGRICULTURAL OPERATION, AGRICULTURAL FACILITY OR EXPANSION THEREOF'.
- 6. DIRECT RESIDENTIAL LOT ACCESS TO MIDLAND BLVD, HIGHWAY 20/26, SKYGATE ST AND SOARING HEIGHTS ST IS PROHIBITED.
- 7. ALL ALLEYS (LOTS 16, 42, AND 71, BLOCK 9) ARE SUBJECT TO A BLANKET UTILITY EASEMENT FOR THE CITY OF CALDWELL FACILITIES, PRESSURE IRRIGATION, STORM DRAINAGE, AND PUBLIC UTILITIES. LOT OWNER'S WITHIN THIS SUBDIVISION HAVE THE PERPETUAL RIGHT OF INGRESS AND EGRESS OVER SAID LOTS AND SAID PERPETUAL EASEMENT SHALL RUN WITH THE LAND. SAID LOTS ARE PRIVATE ALLEYS AND MAINTENANCE FOR SAID LOTS IS AS PROVIDED FOR IN THE COVENANTS, CONDITIONS AND RESTRICTIONS FOR THIS SUBDIVISION. THE RESTRICTIVE COVENANT FOR MAINTENANCE OF THE PRIVATE ALLEYS CANNOT BE MODIFIED AND THE HOMEOWNER'S ASSOCIATION CANNOT BE DISSOLVED WITHOUT THE EXPRESS CONSENT OF THE CITY OF CALDWELL. THE PRIVATE ALLEYS SHALL MEET CITY OF CALDWELL CODE.
- 8. COMMON DRIVE LOTS (LOT 14, 33, AND 58, BLOCK 1. LOT 14, BLOCK 7. LOT 7, 18, AND 25, BLOCK 8) ARE SUBJECT TO A BLANKET EASEMENT FOR THE COMMON DRIVES. SAID COMMON LOTS SHALL BE OWNED AND MAINTAINED BY THE HOMEOWNER'S ASSOCIATION, OR ASSIGNS. SAID COMMON LOTS ARE ALSO SUBJECT TO BLANKET ACCESS AND UTILITY EASEMENTS FOR PRESSURE IRRIGATION, STORM DRAINAGE, AND PUBLIC UTILITIES. LOT OWNER'S WITHIN THIS SUBDIVISION HAVE THE PERPETUAL RIGHT OF INGRESS AND EGRESS OVER SAID LOTS AND SAID PERPETUAL EASEMENT SHALL RUN WITH THE LAND.


AVIARY HEIGHTS SUBDIVIS CALDWELL, IDAHO PLAT LAYOUT - PHASE 1	SEESSIONAL ENGLISH SEONAL SEON	km		
REVISIONS	工 の 10/10/25 の	ENGINEERING		
ITEM	DATE	ON OF WAR	5725 NORTH DISCOVERY WAY BOISE, IDAHO 83713	
		7.V. JUN	PHONE (208) 639-6939	
			kmengllp.com	
			DATE: 10.10.2	
			PROJECT: 22-22	
		SHEET NO.		
		PP2.0		
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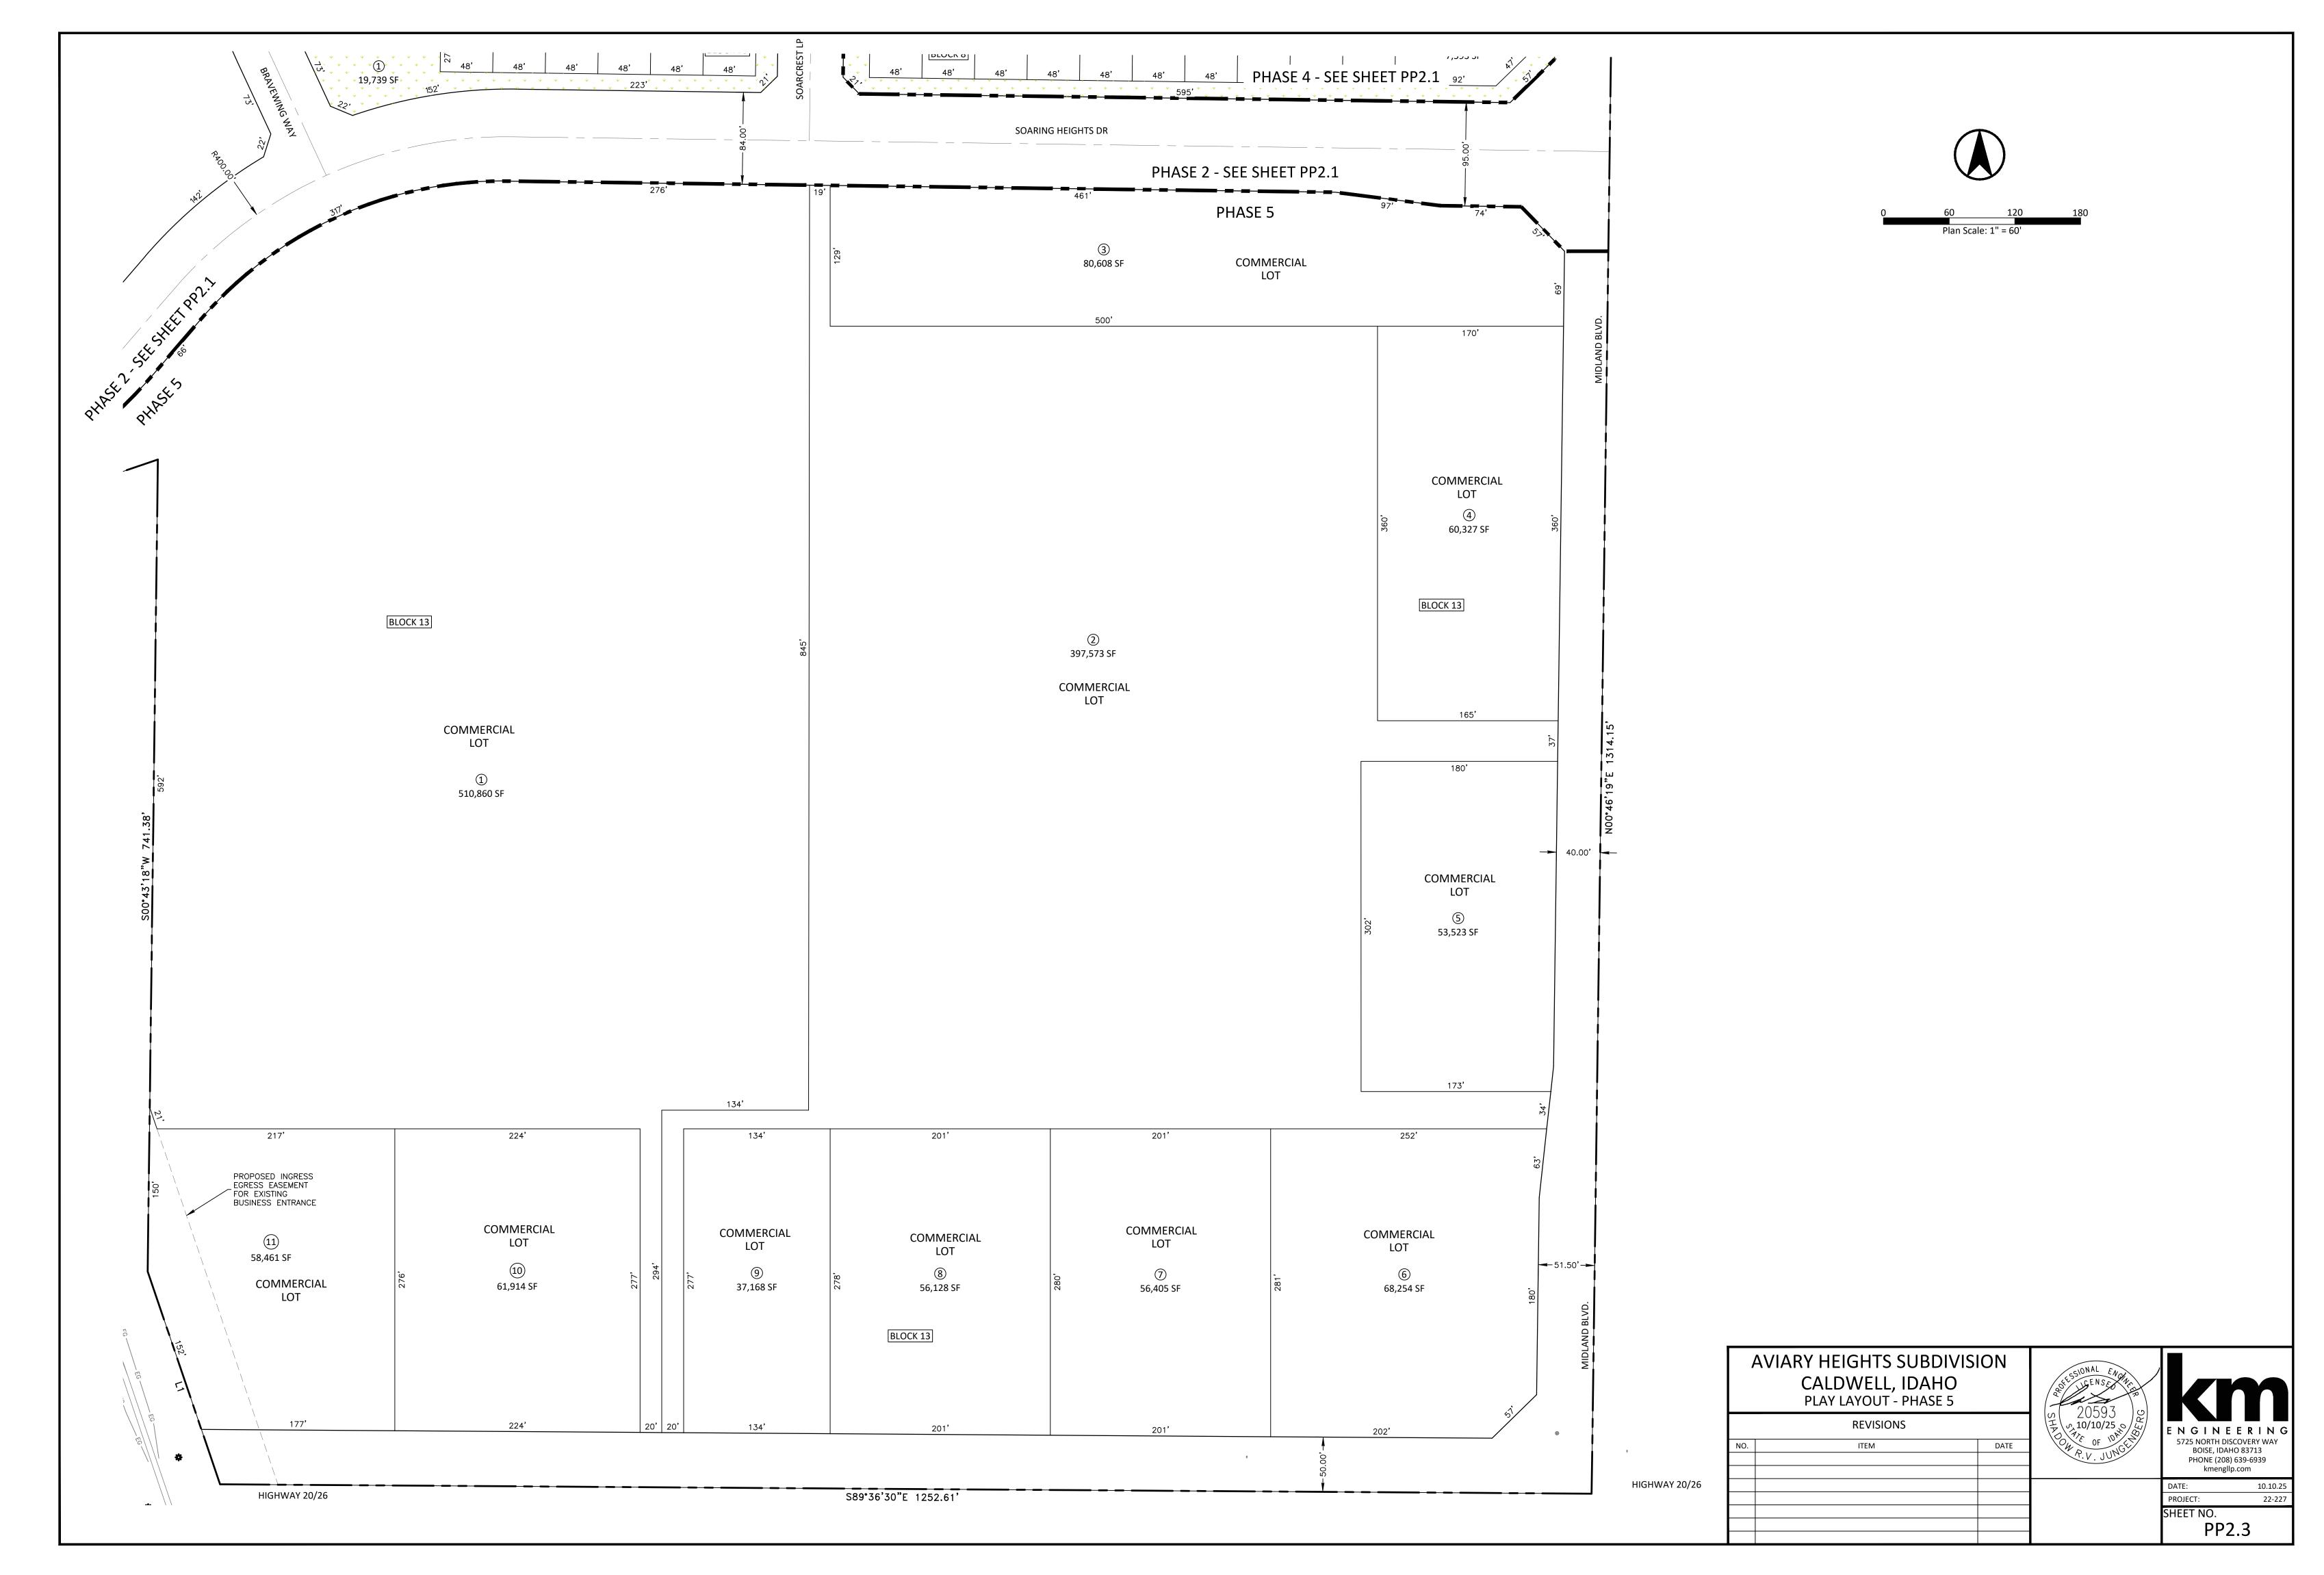
P:\22-227\CAD\ENTITLEMENT PLANS\22-227 P-PLAT LAYOUT.DWG, SHADOW JUNGENBERG, 10/10/2025, CANON IPF755 (BW).PC3, 24X36 L [PDF]

P:\22-227\CAD\ENTITLEMENT PLANS\22-227 P-PLAT LAYOUT.DWG, SHADOW JUNGENBERG, 10/10/2025, DWG TO PDF.PC3, 24X36 L [PI






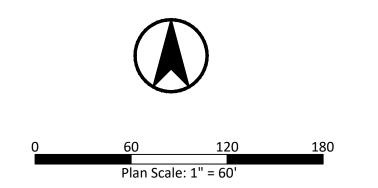

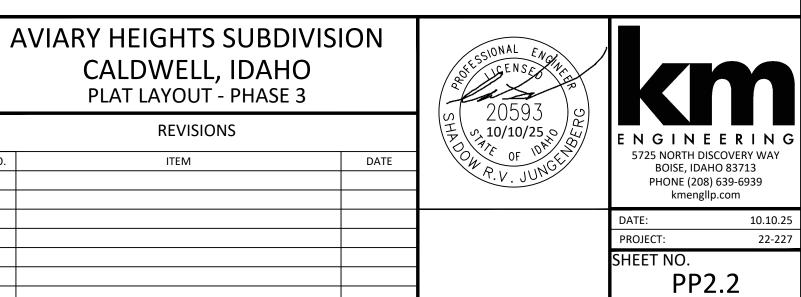

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### PRELIMINARY ENGINEERING NOTES

- 1. DOMESTIC WATER SERVICE WILL BE PROVIDED BY CITY OF CALDWELL. WATER MAINS WILL BE LOOPED THROUGHOUT THE SUBDIVISION CONNECTING TO THE PLANNED WELL LOCATED OFFSITE NEAR THE NORTH WEST CORNER OF THE SITE
- 2. SANITARY SEWER SERVICE WILL BE PROVIDED BY THE CITY OF CALDWELL. THE PROJECT WILL BE PERMANENTLY SERVED BY A MASTER PLANNED GRAVITY SEWER MAIN CONNECTING TO THE LINCOLN ROAD TRUNK MAIN. A TEMPORARY LIFT STATION AND PRESSURE MAIN WILL PROVIDE SUBDIVISION ACCESS TO SEWER INFRASTRUCTURE AND WILL DRAIN SANITARY SEWER TO THE SEWER MAIN INSTALLED IN HIGHWAY 20/26..
- 3. WATER, SEWER AND PRESSURE IRRIGATION LINE SIZES AND LOCATIONS ARE PRELIMINARY AND SHALL BE DETERMINED WITH THE FINAL PLAT DESIGN PHASE.
- 4. ALL DOMESTIC WATER MAINS AND SANITARY SEWER WILL BE INSTALLED IN ACCORDANCE WITH THE IDAHO DEPARTMENT OF ENVIRONMENTAL QUALITY AND CITY OF CALDWELL REQUIREMENTS.
- 5. ALL STREETS SHOWN SHALL BE PUBLIC STREETS OWNED AND MAINTAINED BY THE CITY OF CALDWELL. ALL SHOWN ALLEYS AND COMMON DRIVES SHALL BE PRIVATELY OWNED AND MAINTAINED BY THE HOMEOWNER'S ASSOCIATION AND DESIGNED TO THE CITY OF CALDWELL'S STANDARDS.
- 6. STORM DRAINAGE FROM THE PRIVATE ALLEYS AND STREETS SHALL BE COLLECTED AND ROUTED TO STORM FACILITIES THAT MEET THE CITY OF CALDWELL'S REQUIREMENTS. THE PRIVATE AND PUBLIC STORM FACILITIES, SIZES, AND LOCATIONS ARE PRELIMINARY AND WILL BE ULTIMATELY DETERMINED WITH THE FINAL PLAT DESIGN
- 7. THE PRESSURE IRRIGATION SYSTEM FOR THE PROJECT SHALL CONNECT TO THE AVIARY SUBDIVISION PRESSURE IRRIGATION IMPROVEMENTS. THE PROPOSED PRESSURE IRRIGATION SYSTEM SHOWN IS PRELIMINARY AND WILL BE DETERMINED WITH THE FINAL PLAT DESIGN PHASE.
- 8. CONSTRUCTION OF THE FOLLOWING IMPROVEMENTS WILL BE IN COMPLIANCE WITH THE STANDARD CALDWELL CONSTRUCTION NOTES: DRAINAGE, SEWER, WATER, AND PRESSURE IRRIGATION.
- 9. CITY OF CALDWELL SANITARY SEWER AND WATER EASEMENT LOCATIONS SHALL BE DETERMINED DURING THE FINAL PLAT DESIGN PHASE.
- 10. PUBLIC UTILITIES, PRESSURE IRRIGATION, AND DRAINAGE EASEMENTS SHALL BE DETERMINED DURING THE FINAL PLAT DESIGN PHASE.
- 11. THE STREETS AND ALLEYS SHALL BE CONSTRUCTED PER THE STREET SECTIONS SHOWN ON SHEET P3.2. THE PAVEMENT SECTION THICKNESS SHOWN IS PRELIMINARY AND SHALL BE DETERMINED DURING FINAL DESIGN.
- 12. PEDESTRIAN CROSSING LOCATIONS ALONG STREETS SHALL BE DETERMINED DURING FINAL DESIGN.
- 13. FIRE HYDRANTS AND STREET LIGHT LOCATIONS SHALL BE DETERMINED DURING THE FINAL DESIGN PHASE.
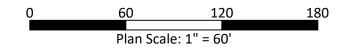
## **KEYNOTES (TYPICAL)**

- 1. PROPOSED 12" WATER MAIN IN MIDLAND BLVD.
- PROPOSED 12" WATER MAIN IN LOCAL COLLECTOR SKYGATE ST. 12" MAIN TO EXTEND TO PLANNED WELLS SITE LOCATED OFFSITE NEAR NW CORNER OF SUBDIVISION.

AND STUB WATER MAIN FOR FUTURE EXTENSION.

- 3. PROPOSED TEMPORARY SEWER LIFT STATION AND PRESSURE SEWER MAIN. LIFT STATION AND PRESSURE SEWER MAIN TO BE ABANDONED WHEN PLANNED, GRAVITY MAIN INFRASTRUCTURE IS PRESENT FROM THE NORTH.
- PROPOSED STORM DRAIN SEEPAGE BED.
   PROPOSED GRAVITY IRRIGATION PIPED SYSTEM.
- 6. LOWER FIVE MILE DRAIN EASEMENT AND PROJECT BOUNDARY.

	CALDWELL, IDAHO ENGINEERING LAYOUT - PHASE 1						
	REVISIONS		SHA				
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AVIARY HEIGHTS SUBDIVISION



E N G I N E E R I N C 5725 NORTH DISCOVERY WAY BOISE, IDAHO 83713 PHONE (208) 639-6939 kmengllp.com

DATE: 10.10.25
PROJECT: 22-227
SHEET NO.
PP3.0

P:\22-227\CAD\ENTITLEMENT PLANS\22-227 P-PLAT ENGINEERING.DWG, SHADOW JUNGENBERG, 10/10/2025, CANON IPF755 (BW).PC3, 24X36 L [PI


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PP3.3

#### **Street Name Request Form**

	1011-10-		
Project Location	20/26 & Midland Blvd	Resubmission Required:	
Project Name:	Aviary Heights	Approved:	
	•		

Submittal Number:			Da	te:	10/	17/2	25							
		FOR STAFF RE							REV	IEW				
Descripted Chroat Names		Street Name					Street Suffix						Nista	
Requested Street Name	Approved			Denied		ed	Approved			Denied			Notes	
SOARING HEIGHTS DR													COLLECTOR	
BRAVEWING WAY														
SOARCREST LP														
FEATHER CREST ST														
DOWNFEATHER LN													ALLY (FOR ADDRESSING	
WHIRLWING LN													ALLY (FOR ADDRESSING	
TAILWIND LN													ALLY (FOR ADDRESSING	
PLUME AVE														
SKYGATE ST													COLLECTOR	
EAGLEWING AVE														
FLIGHT PATH AVE														
SKYRUN AVE														
SWIFTLIGHT ST														
AERIAL HEIGHTS AVE														
UPDRAFT AVE														
AIR AVE														
SOARING GAIL AVE														
FEATHERTAIL ST														
FEATHER FALL AVE														
GILDEWING AVE														
GILDEWING PL														
HATCHLING CT														
PERCH VIEW DR														

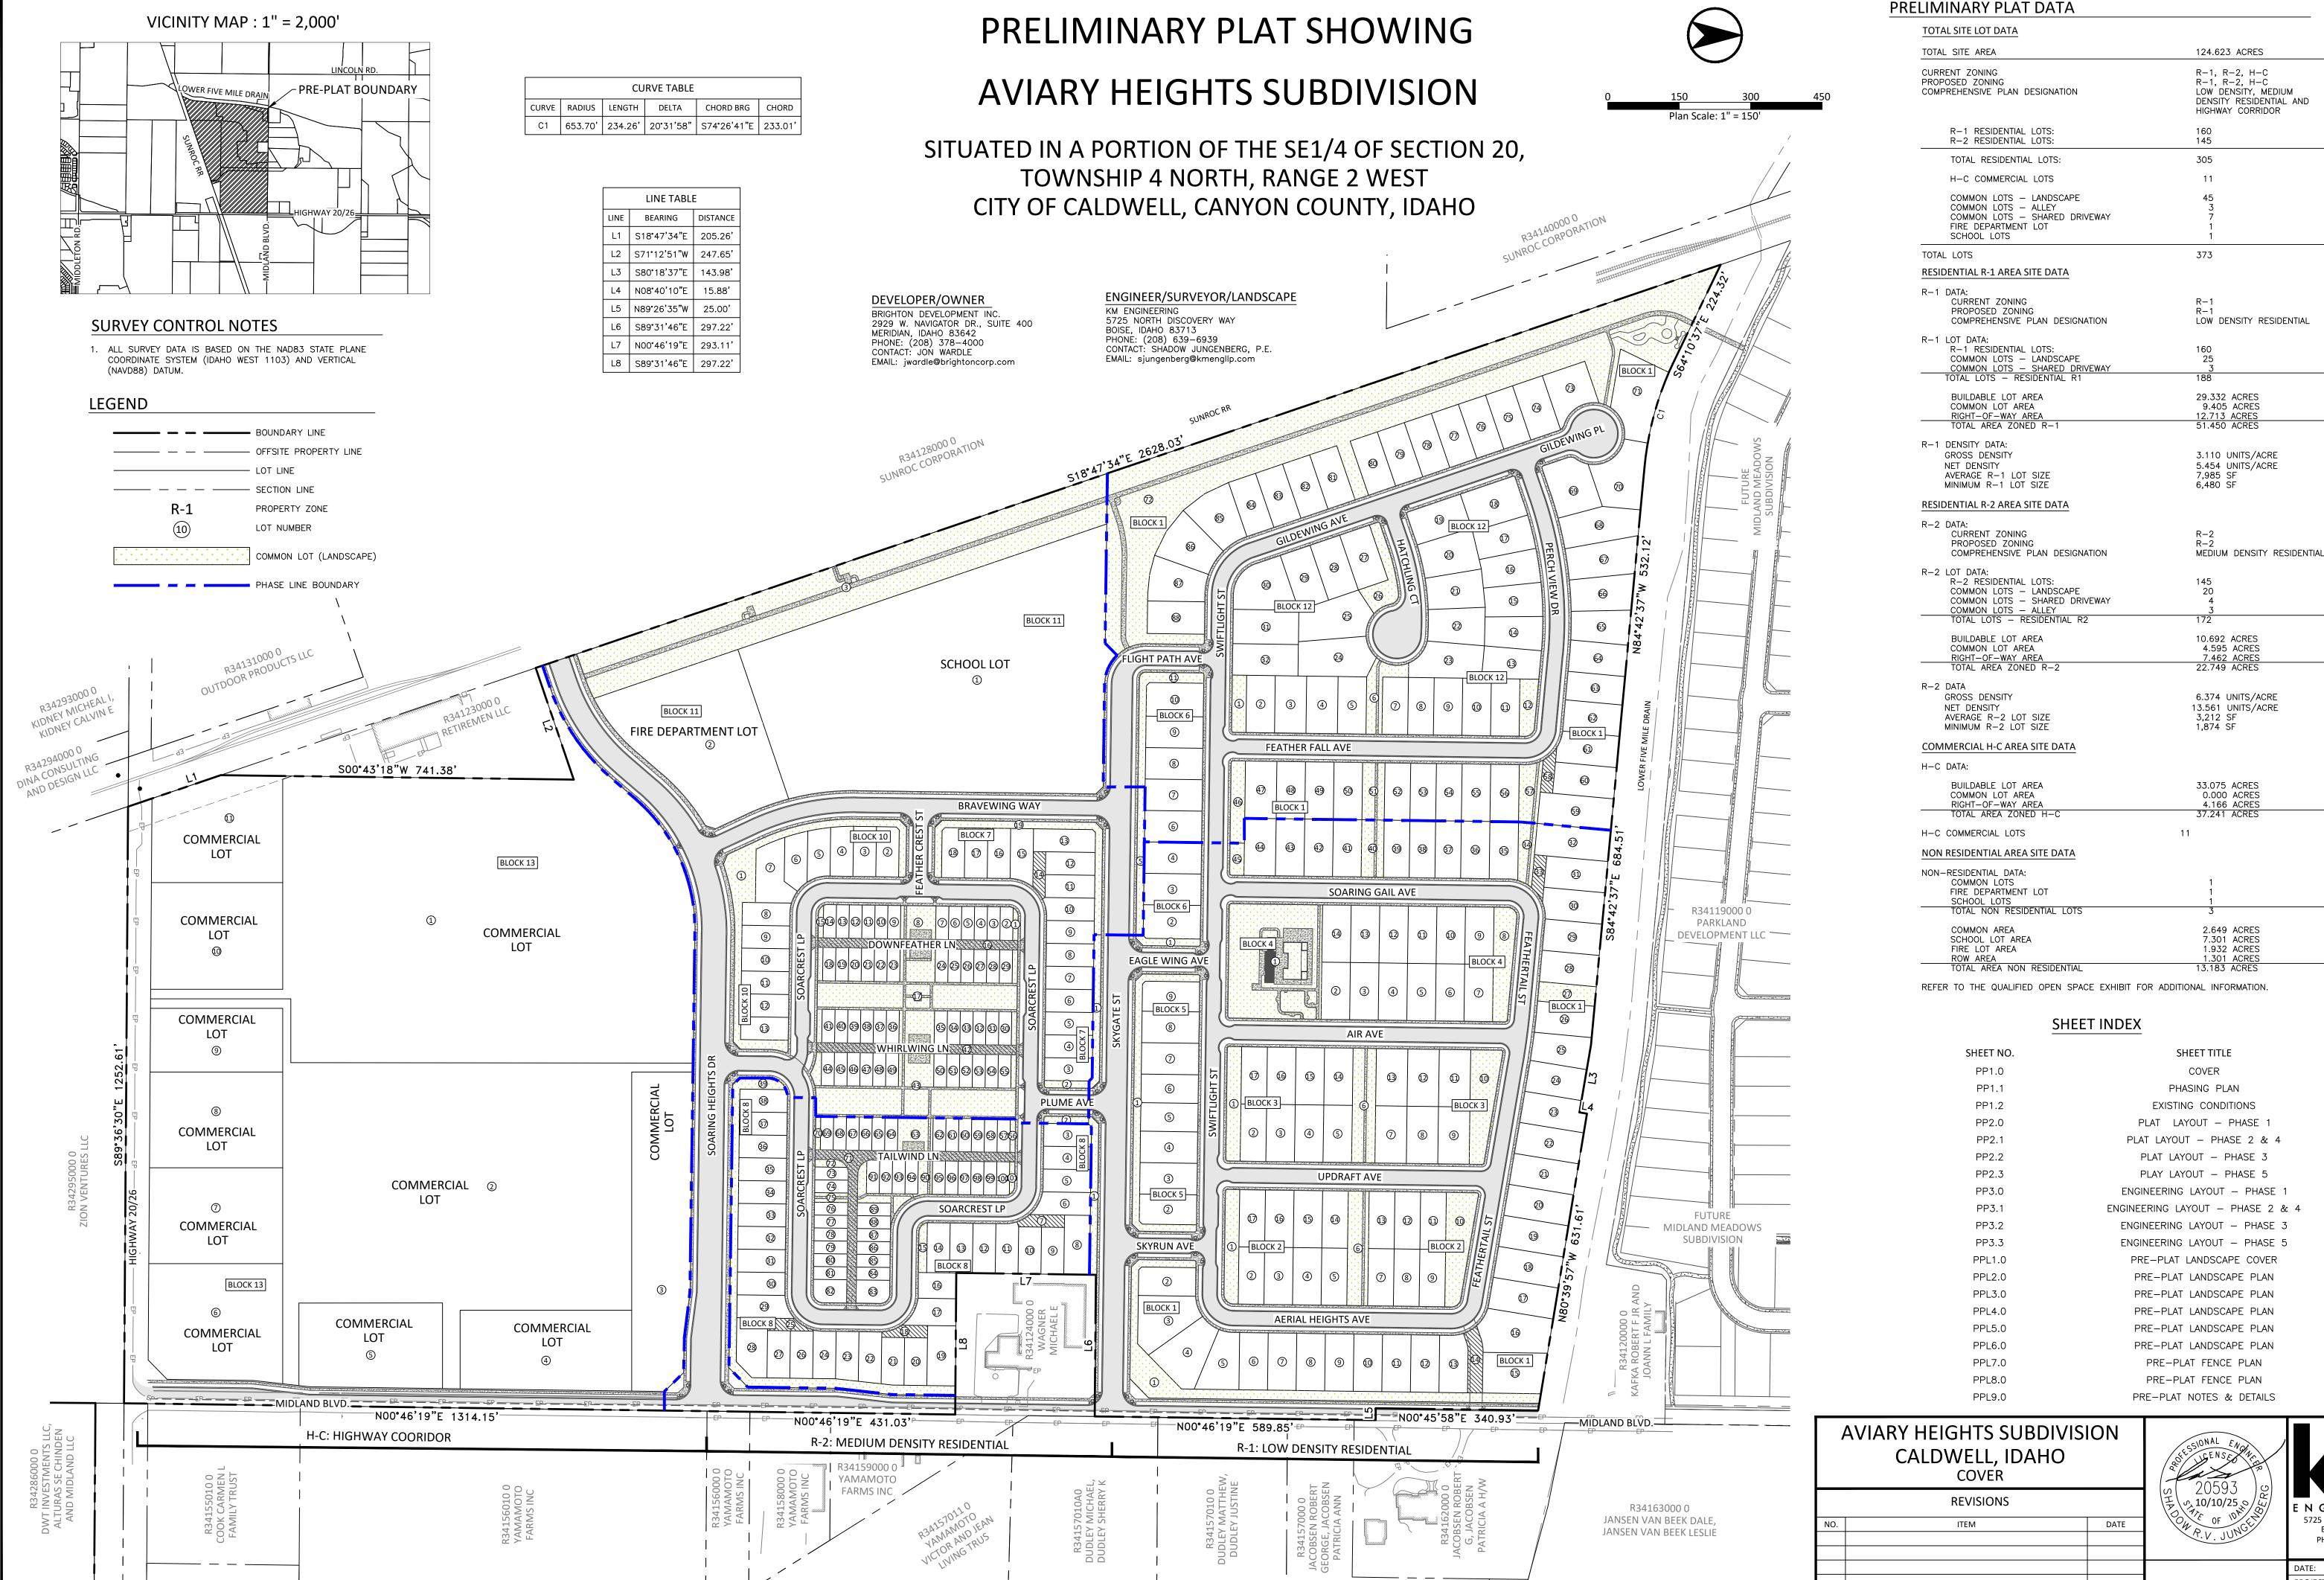

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PROJECT: SHEET NO. PP1.0









