

CITY OF Galdwell, Idaho

Planning & Zoning

HEARING REVIEW APPLICATION

Type of Review Requested (check all that apply)	
Annexation/Deannexation Appeal/Amendment Comprehensive Plan Map Change Design Review Ordinance Amendment Rezone Special Use Permit Subdivision- Preliminary Plat Subdivision- Final Plat Subdivision- Short Plat Time Extension Variance Other	STAFF USE ONLY: File number(s): Project name: Date filed: Date complete: Related files:
Subject Property Information	
Address: 102 N. 37d Ave. Culdwell Subdivision: Golden Cute Add Block: 46 Prior Use of the Property: Vesidental S Proposed Use of the Property: Vesidental S	Lot: Acreage: 0:30 Zoning:
Applicant Information:	SIVILITE TOUVITUJ VIUVVIP
Applicant Name: Ideal Custom Home	25 Nov. 708. 704 6727
Address: 15777 QUALVTZ LM. City: M	
Email: Katil. Weal custom homes egma	
Owner Name: BUYKE Deal Address: 15777 QUAYTZ LM. City: WE Email: buyke@ IdeMcustomhumes. Net	Phone: <u>208-794-6732</u> Ider State: <u>ID</u> zip: <u>83676</u>
Agent Name: (e.g., architect, engineer, developer, representat	tive) Kattl Deal
Address: 15777 QUANTZ Ln. City: Wi Email: Kutie. Ideuloustomhomes CO	
Authorization	
Print applicant name: Kathe Deul	
Applicant Signature: Kata Dal	Date: 12 27 2023



GENERAL PROJECT INFORMATION

City of Caldwell Planning and Zoning Department

Phone: (208) 455-3021 | Web: www.cityofcaldwell.org

Public Amenities: Location, size, and types of new structures for recreational use (i.e., gazebos, water features; picnip-areas, shuffleboard, etc.)

SECTION 6: Information Tables

Type of land uses within subdivision:	Mixed-use (mix of residential and non-residential uses)						
Has your development / subdivision name, street names, and lot and block numbers been approved by the City of Caldwell Mapping Division?	If yes, have you made any changes or modifications to the previously approved pre-plat approved by Mapping? ☐ Yes ☐ No						
Will the subdivision be phased?	☐ Yes No If yes, how many phases are proposed?						
Development timeline for full build out?	d treps	i year					
LAND USE AND ZONING INFORMAT	TION						
The state of the s	ATALY C						
Existing (Subject Property)	Zoning Designation	Comp Plan Designation	Vacuation i				
Proposed (Subject Property)	TON		residential				
North of Site	172 Aud Auf + 12-7		residential				
South of Site	BELLEVILLE C	1	residential				
East of Site	ESSISTEMAN P	<i></i>	residential				
West of Site	L-L		residenticul				
	10-6	7	residential				
	V	lease advise on i	old or new comp plu				
PROJECT SPECIFIC INFORMATION							
Total avea 0.43	Number of Lots	Acres	Percent of "Net" Acres Net acreage is the total acreage minus any public streets and public rights of				
Residential Lots	6	0.151	0:35				
Commercial Lots	0	0	0.33				
Industrial Lots	0	0					
Common Lots	Ž	0.058	0.13				



	# of EXISTING buildings	# of PROPOSED buildings	# of EXISTING dwelling units	# of PROPOSED dwelling units	Max. Building Height	Total GROSS square footage of
Residential:						buildings
Single family (detached) homes			7	(1)		
Townhomes	6	15	-	7/		
Two-family (duplex)						
Three-family residential (triplex)						
Four, five and six family (fourplex, five plex, and six plex)	0	1	2	0		
Multi-family (7 or > dwelling units) in a single building	Ø					
Commercial	1		N/A	N/A		
Industrial			N/A	N/A		
Type of Commercial or Industrial Buildings:		0	Single-tenant build	fings Kmulti-te	nant buildings	

DENSITY AND OPEN SPAC	E		554		
Dwelling units per	Max. Allowed	Proposed			
gross acre (Density):	13.95	6			
Total Open Space	% Required	% Proposed	Acreage Proposed		
otal Open Space	10.7,	OM90 197.	0.06		
Total "Qualifying"	% Required	% Proposed	Acreage Proposed		
Open Space					



	Min. # Required	# Proposed
Electric vehicle parking spaces	0	0
Off-street parking spaces	1 7	2
Commercial loading spaces	ō	Ö
Industrial loading spaces	0	0
Sicycle parking spaces:	0	0
ablic Transportation:	Describe any public transportation facilities that a	re proposed.
Public Amenities:	Describe any public amenities that are being prop	osed.



Location (Enter Street Name)	Min. Width Réquired	Proposed Width	% of Sod Proposed	# of Trees Proposed	Min. Tree Spacing (in feet)	# of Shrubs Proposed	Min. Shrub Spacing (in feet)
N. 3rd Ave	20'	201	70.1.	4	35	22	7
Joilet	10.	101	70 .	2	35	13	7

Location	Proposed Buffer Width	% of Sod Proposed	# of Trees Proposed	Min. Tree Caliper at Planting	Min. Tree Spacing (in feet)	# of Shrubs Proposed	Size of Shrubs at Planting (in gallons)	Min. Shru Spacing (in feet)
North Property Line		TET.	1 4				[HI Genons)	
South Property Line		10,41	-					
East Property Line	1							
West Property Line								

SIDEWALKS			
Location (Street Name)	Existing Sidewalk?	Proposed Width	Type of Proposed Sidowalk
N. Brot Avenue	N Yes □ No If existing, specify width: 5 ¹	5'	☐ Meandering 🗓 Attached ☐ Detached
Joliet	If existing, specify width:		☐ Meandering ☐ Attached ☐ Detached
	☐ Yes ☐ No If existing, specify width:		☐ Meandering ☐ Attached ☐ Detached
	☐ Yes ☐ No If existing, specify width:		☐ Meandering ☐ Attached ☐ Detached



UTILITIES INFORMATION							
		Individual Domestic Well – How Many?					
	0	Centralized Public Water System					
Domestic Water:	×	City Municipal Water System					
		N/A					
	Neares	t Water Line Connection:					
		☐ Individual Septic					
Sewer (Wastewater):	X	City Municipal Sewer					
Series (Wastewater).		N/A					
	Neares	t Sewer Line Connection;					
Irrigation:	0	Surface					
		☐ Irrigation Well					
	X	Pressurized					
		Gravity					
invigation dan	0	N/A					
included	Neares	t Irrigation Connection:					
" L'O'IVE	Irrigatio	on District Golden Gate Irrigation District					
	D	Swales Swales					
		Ponds					
Stormwater:		Borrow Ditches					
	*	Other, Explain: PERMERIOLE PRIVERS					
Stormwater Management:	Does the site disturb one or more acres of land? ☐ Yes ☐ No						
Fire Suppression Water Supply Source:	NIA						
Sources of Surface Water on or Nearby Properties (i.e., creeks, ditches, canals, lake, etc.):		NA					



	A	Street Frontage		
Type of Site Access:	Ü	Easement If easement, specify width:	Instrument #	
Street(s) Providing Access:		N. 3và Ave		
Will Secondary Access for Fire be Provided:	□ Yes	No please describe:		
(A)	П	Public		
Internal Roads: NA	П	Private		
miernai Roads. 14.	U	Internal Circulation		
	ū	Road User's Maintenance Agreem	ent Inst#	
School Districts Serving this Location	4	Caldwell School District		
School Districts Serving this Location:	0	Vallivue School District		



	Yes	No	If yes, explain:
Areas of Critical Environmental Concern?	п	А	
Evidence of Erosion?	0	A	
Fish Habitat?	0	×	
Floodplain?	D	N	
Riparian Vegetation?	U	Ħ	
Steep Slopes?	D	1/4	
Streams/Creeks?	0	-8	
Unique Animal/Plant Life?	Ö	妆	
Unstable Soils?	0	18	
Wildlife Habitat?	0	A	
Historic Buildings or Features?	0	4	
Describe any other unique site characteristics:	T	here	is none noted



LANDSCAPING AND PATHW	AYS
Landscaping:	Please check all locations where landscaping will be provided □ Parking lot ☑ Common areas ☒ Street landscape buffers □ Between different land uses □ Adjacent to Pathways □ Around building exterior Other
Major Pathways:	Describe location, width, and landscaping.
Micro Pathways:	Describe location, width, and landscaping.
Public or Regional Pathways	Describe location, width, landscaping, and fencing per Bicycles and Pathways Master Plan.

Project Narrative

The proposed activity/development for the address 1102 N 3rd Ave. Caldwell is to tear down the existing house on the property and construct a townhouse development. We are proposing to construct seven individually owned townhomes. This land has potential to greatly benefit the city of Caldwell and the residents that currently are faced with difficulty buying affordable homes. The land is an excellent opportunity for affordable housing that utilizes existing infrastructure for an infill project.

Our proposal is to divide the current parcel into seven lots and build individually owned townhomes. The plan we are presenting will allow for the seven homes to be built taking into consideration the setbacks and easements and be up to code according to all departments. We see this proposal as a good use of the land while maximizing the benefit to the community by providing the most units of affordable housing possible. The proposal meets all density requirements and is a good fit for the surrounding neighborhood as it is a mix of industrial, commercial and residential surrounding the property.



REAR ELEVATION

A-201 SCALE: 3/16" = 1'-0"

Phone 208-989-1422
E-MAIL: gary@lawson-design.com

FAL SUBDIVISION 102 N. 320 AVENUE

TOEAL CUSTOM HOMES

Revision No. Description:

Date:

Date:

Date:

DO NOT SCALE DRAWINGS

Drawn By: Date:

WSON DESIGN INC. Monday, September 8, 2025

Scale: JOB NUMBER:

A-201


Drawing Title:
ELEVATIONS





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ELEVATIONS






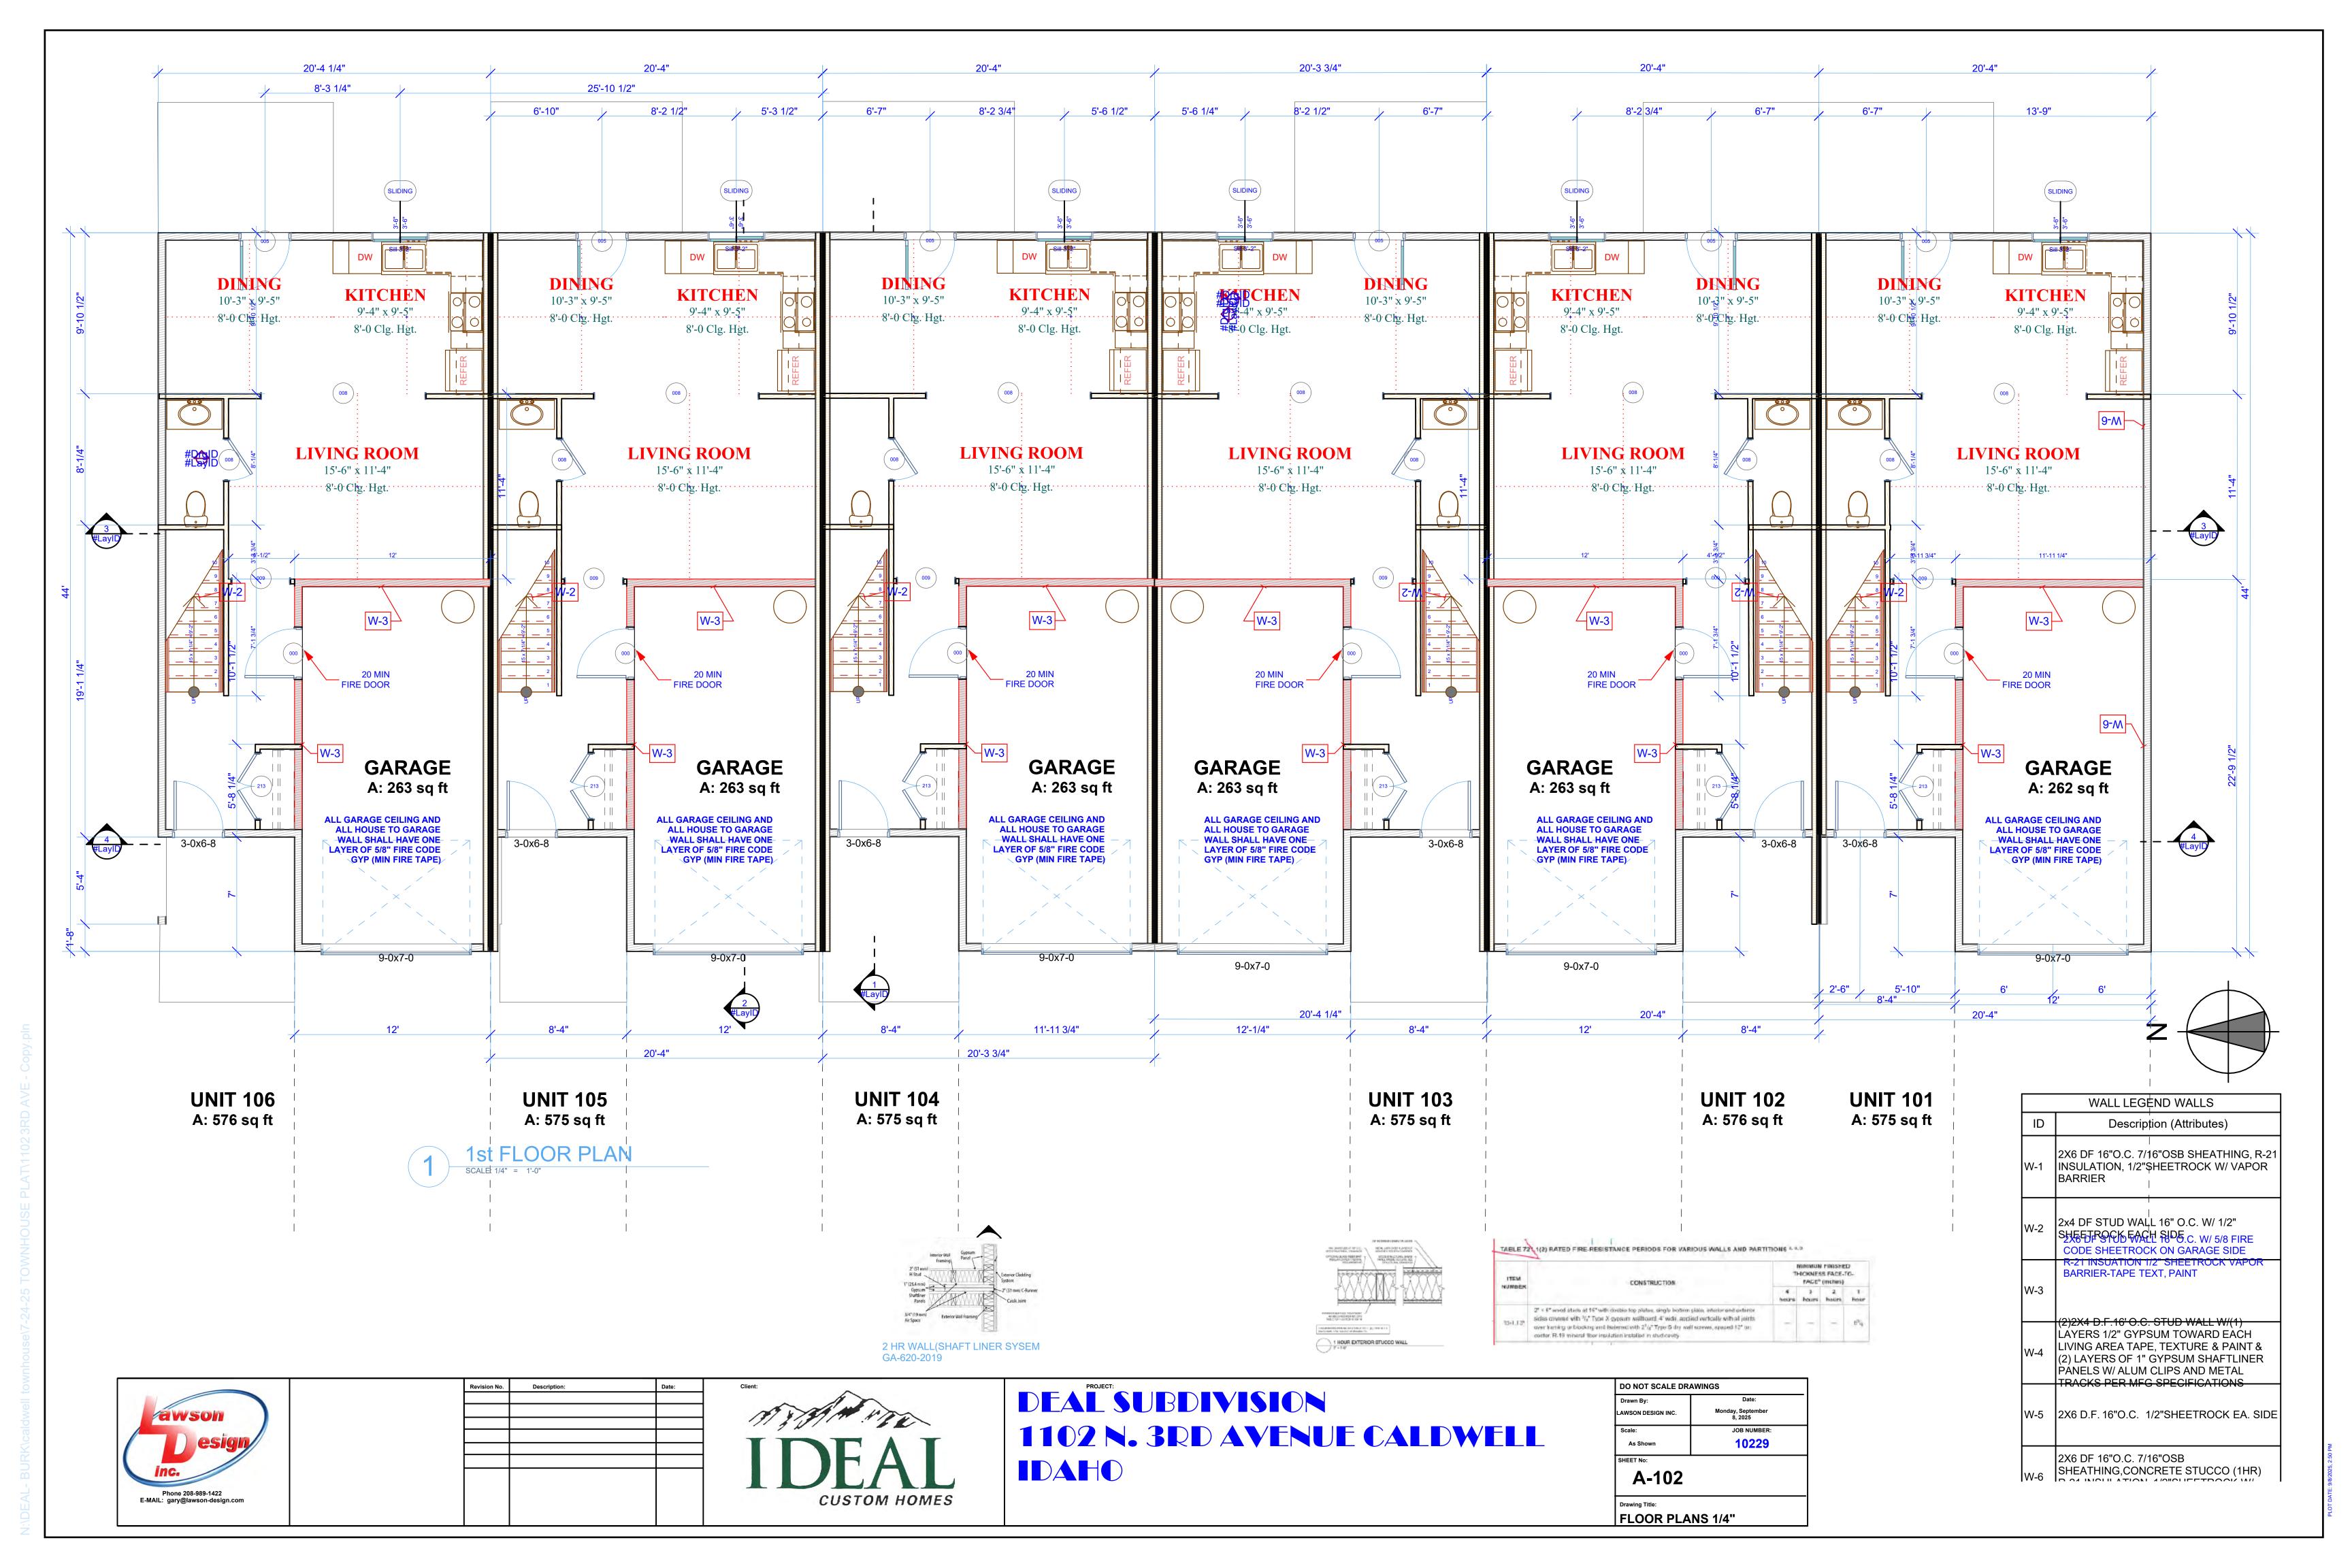

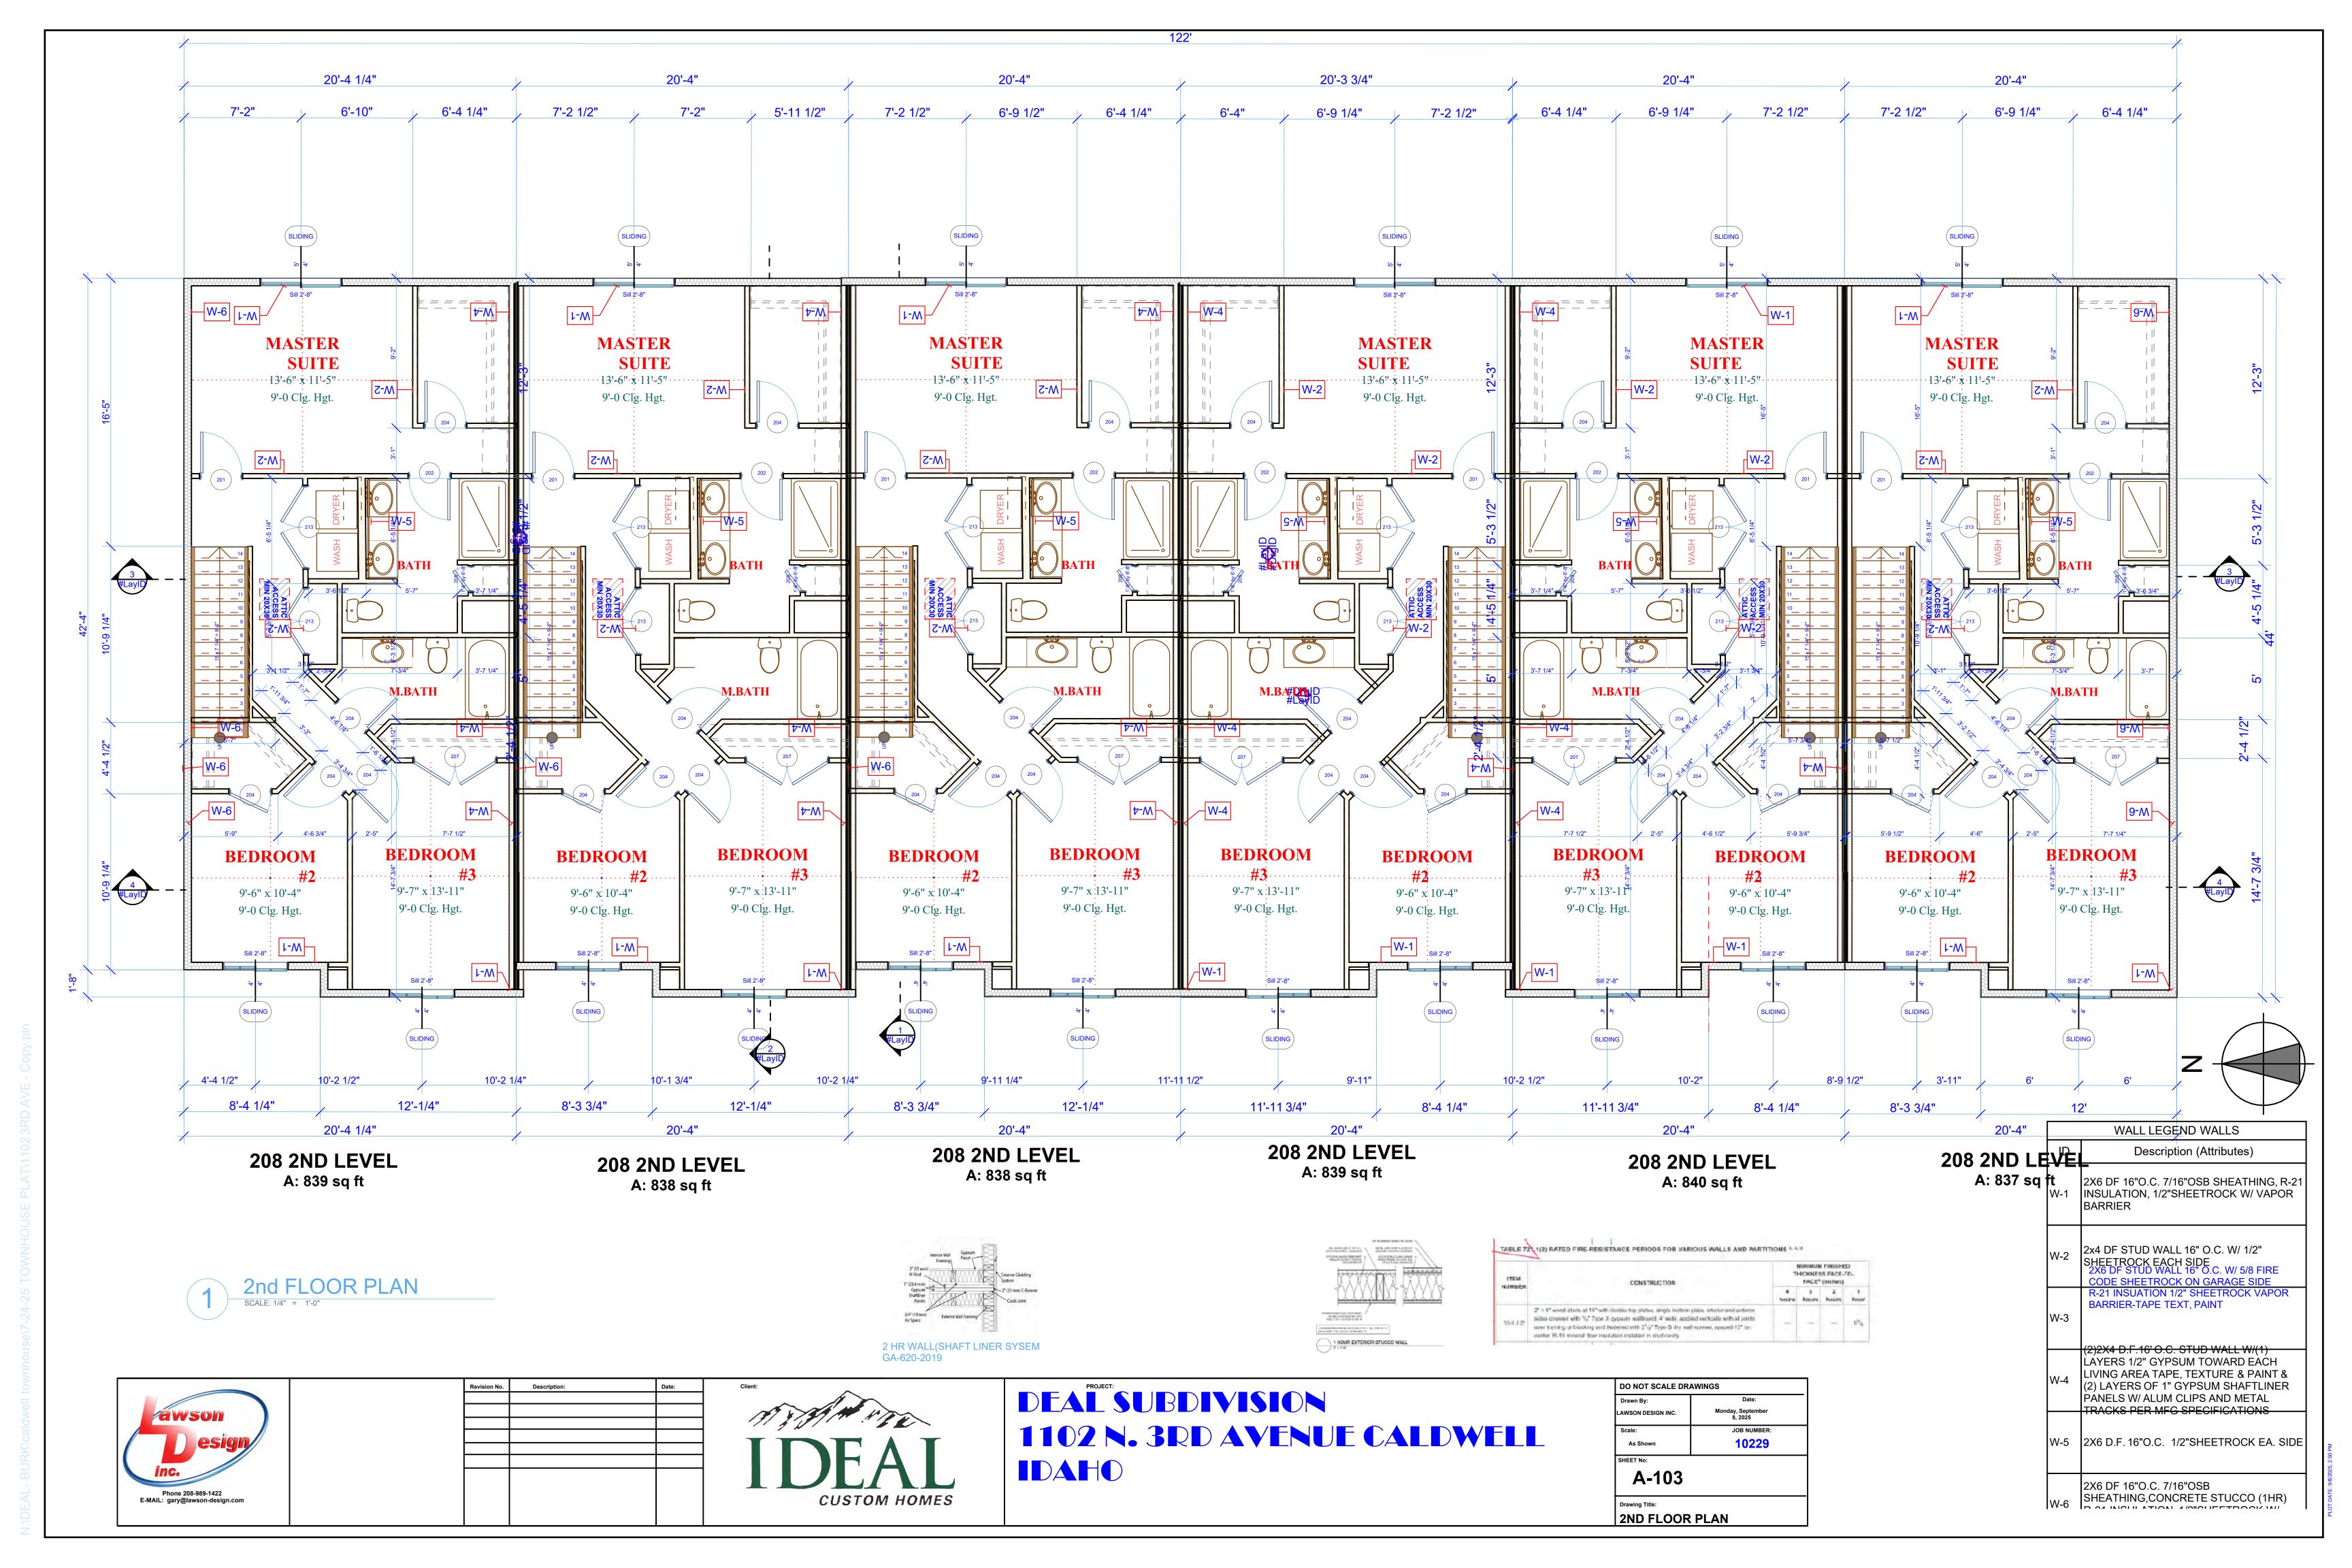

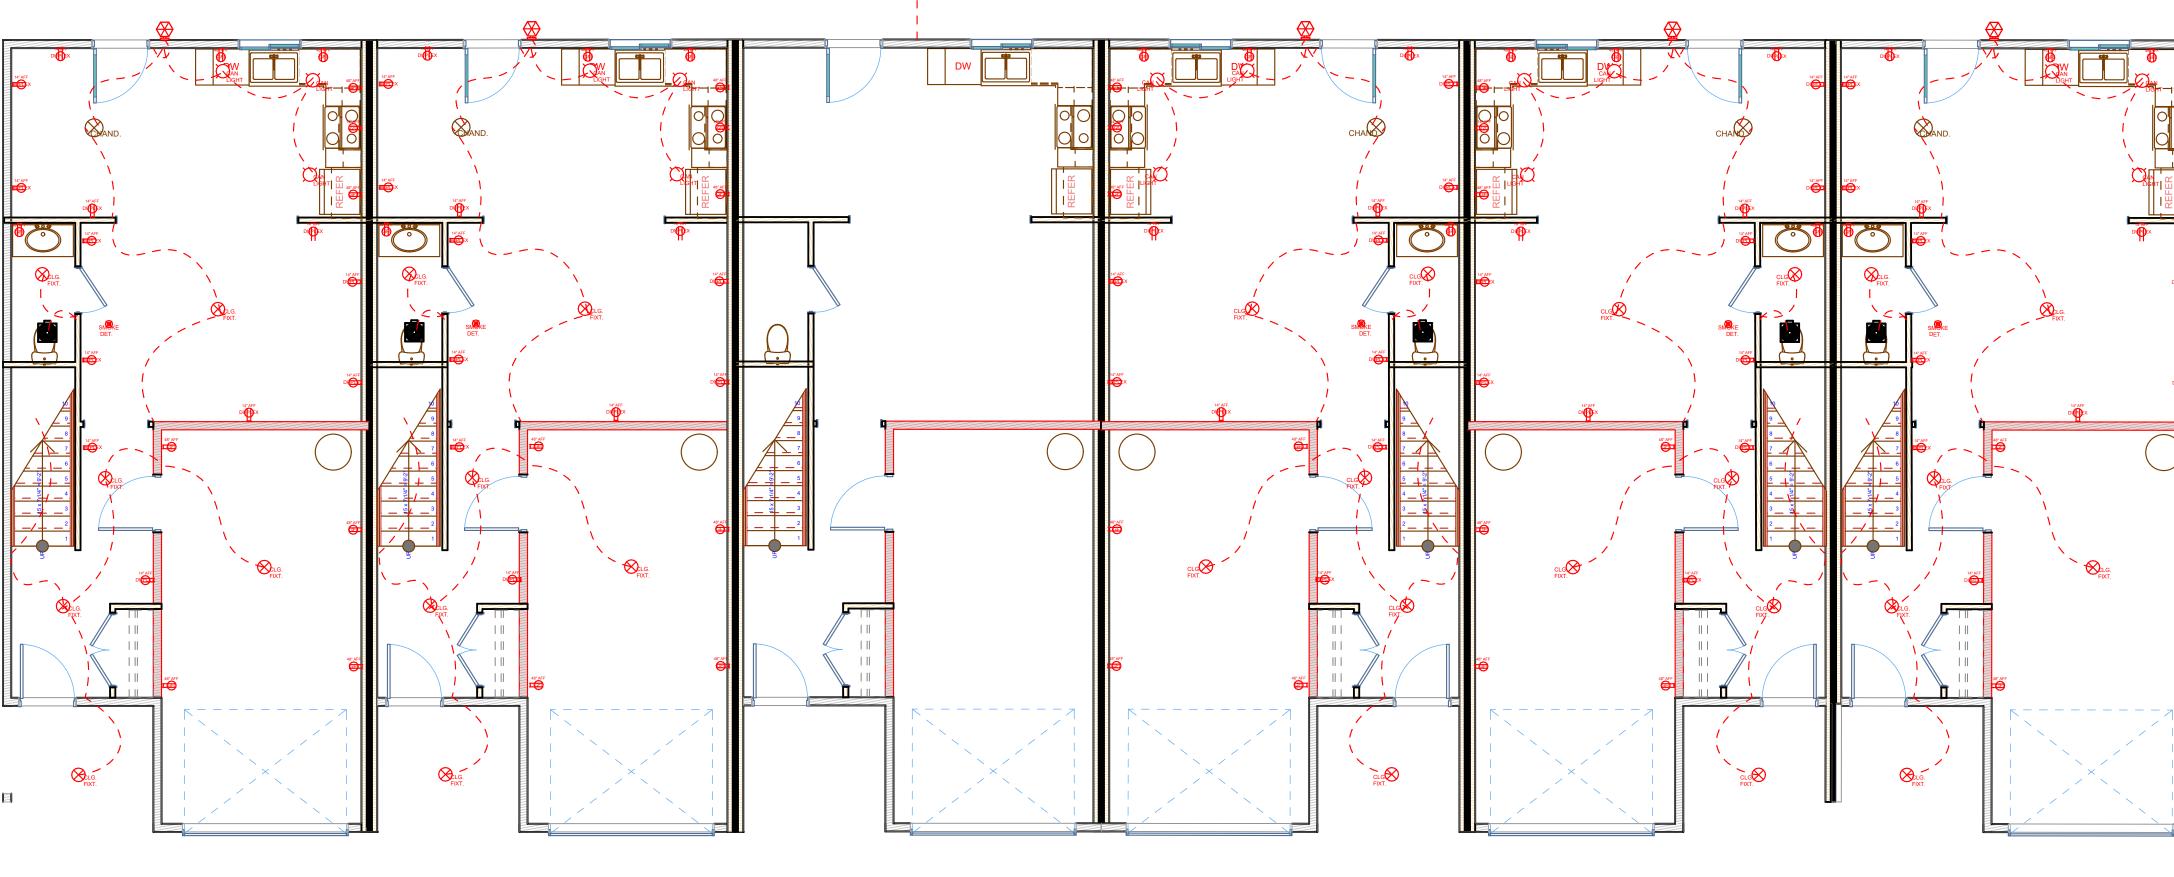1 LEVEL 1 ELECTRICAL

SCALE: 3/16" = 1'-0"

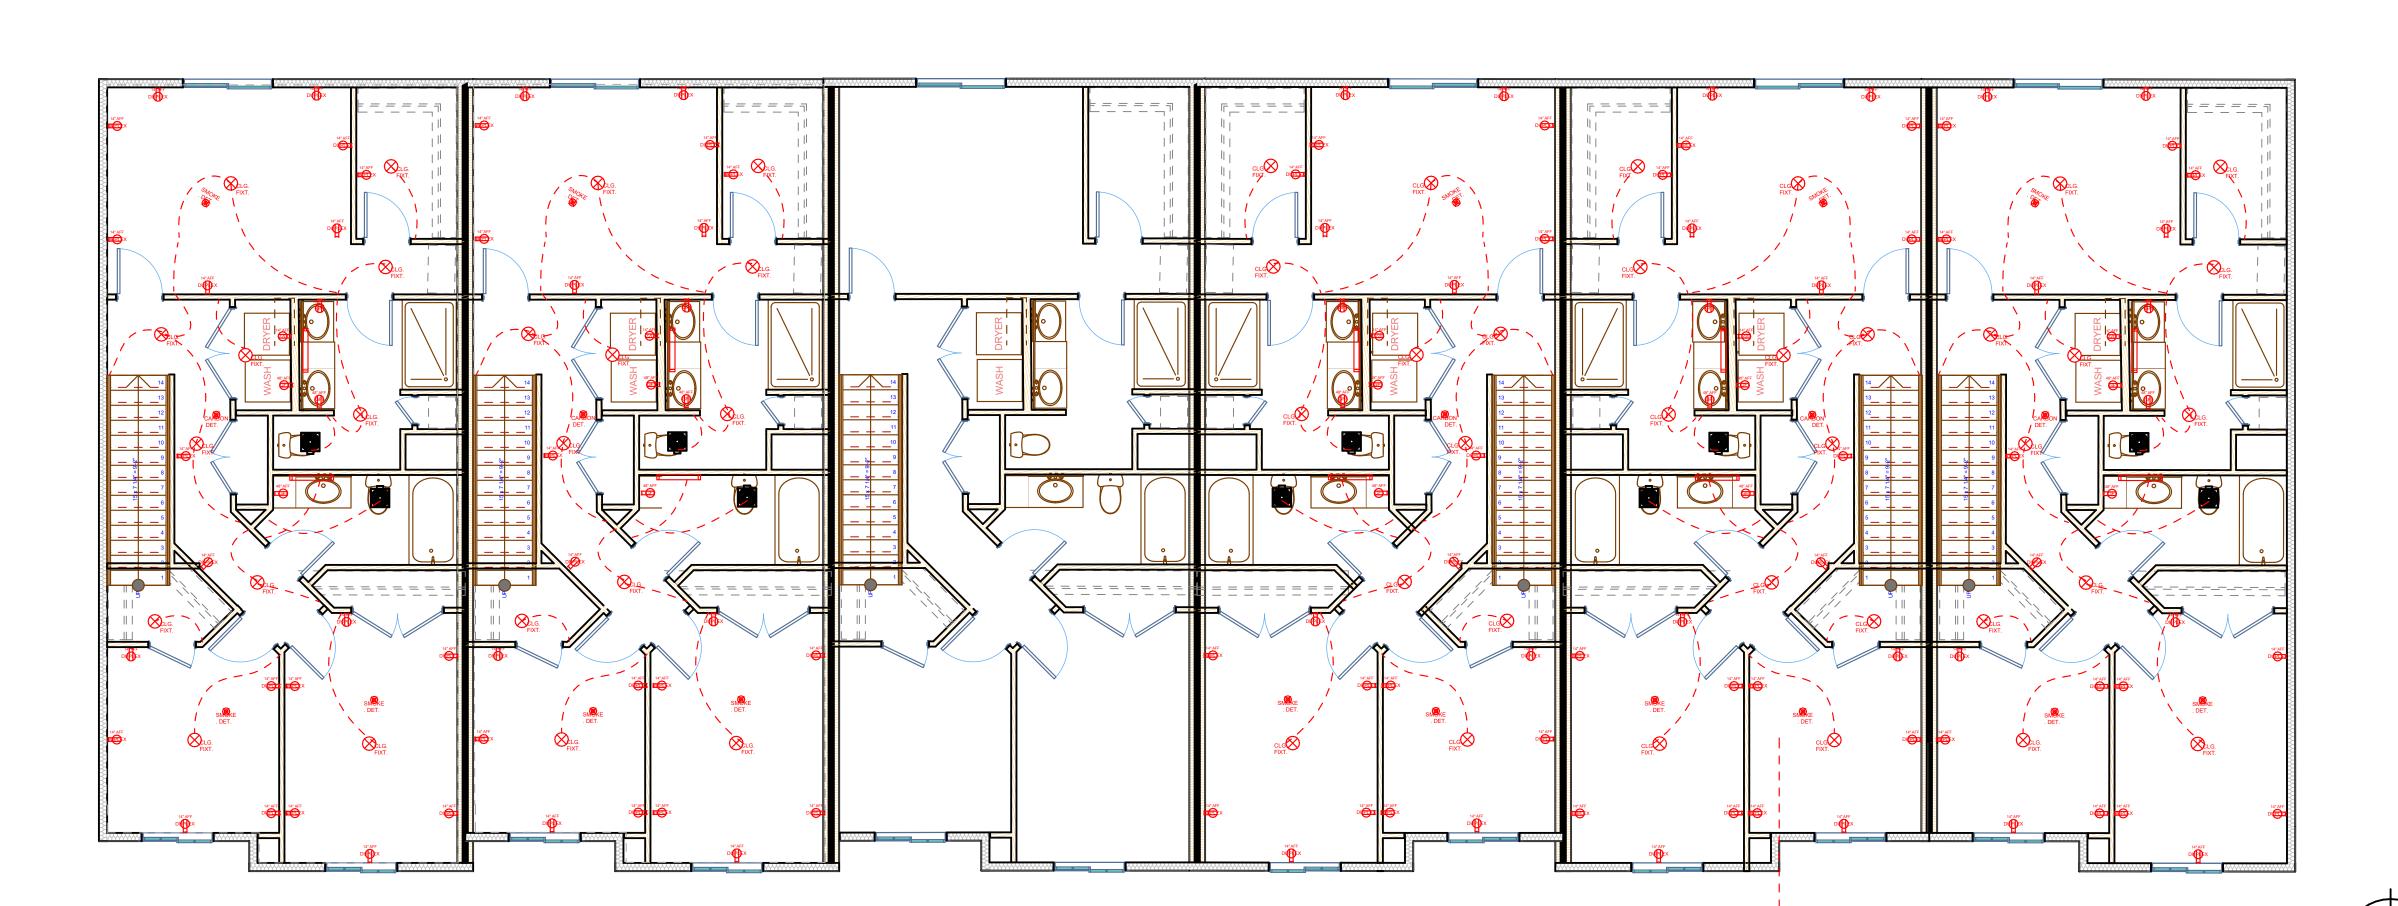

М	MECHANCIAL LEDGEND		
2D Symbol	ITEM	Quantity	
	50 CFM Exh. Fan	32	
14. VEE	220	16	
	BAR LIGHT	24	
CAN	CAN LIGHT	48	
ELG. FIXT.	CEILING LIGHT	136	
AND.	CHANDLER	8	
	DUPLEX	281	
SMORE CARB. DET.	SMOKE DECTOR	32	
	WALL SCONCE	8	


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	DUPLEX	281
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	WALL SCONCE	8




PROFESSIONAL SEAL

DO NOT SCALE DRAWINGS

ELECT PLANS

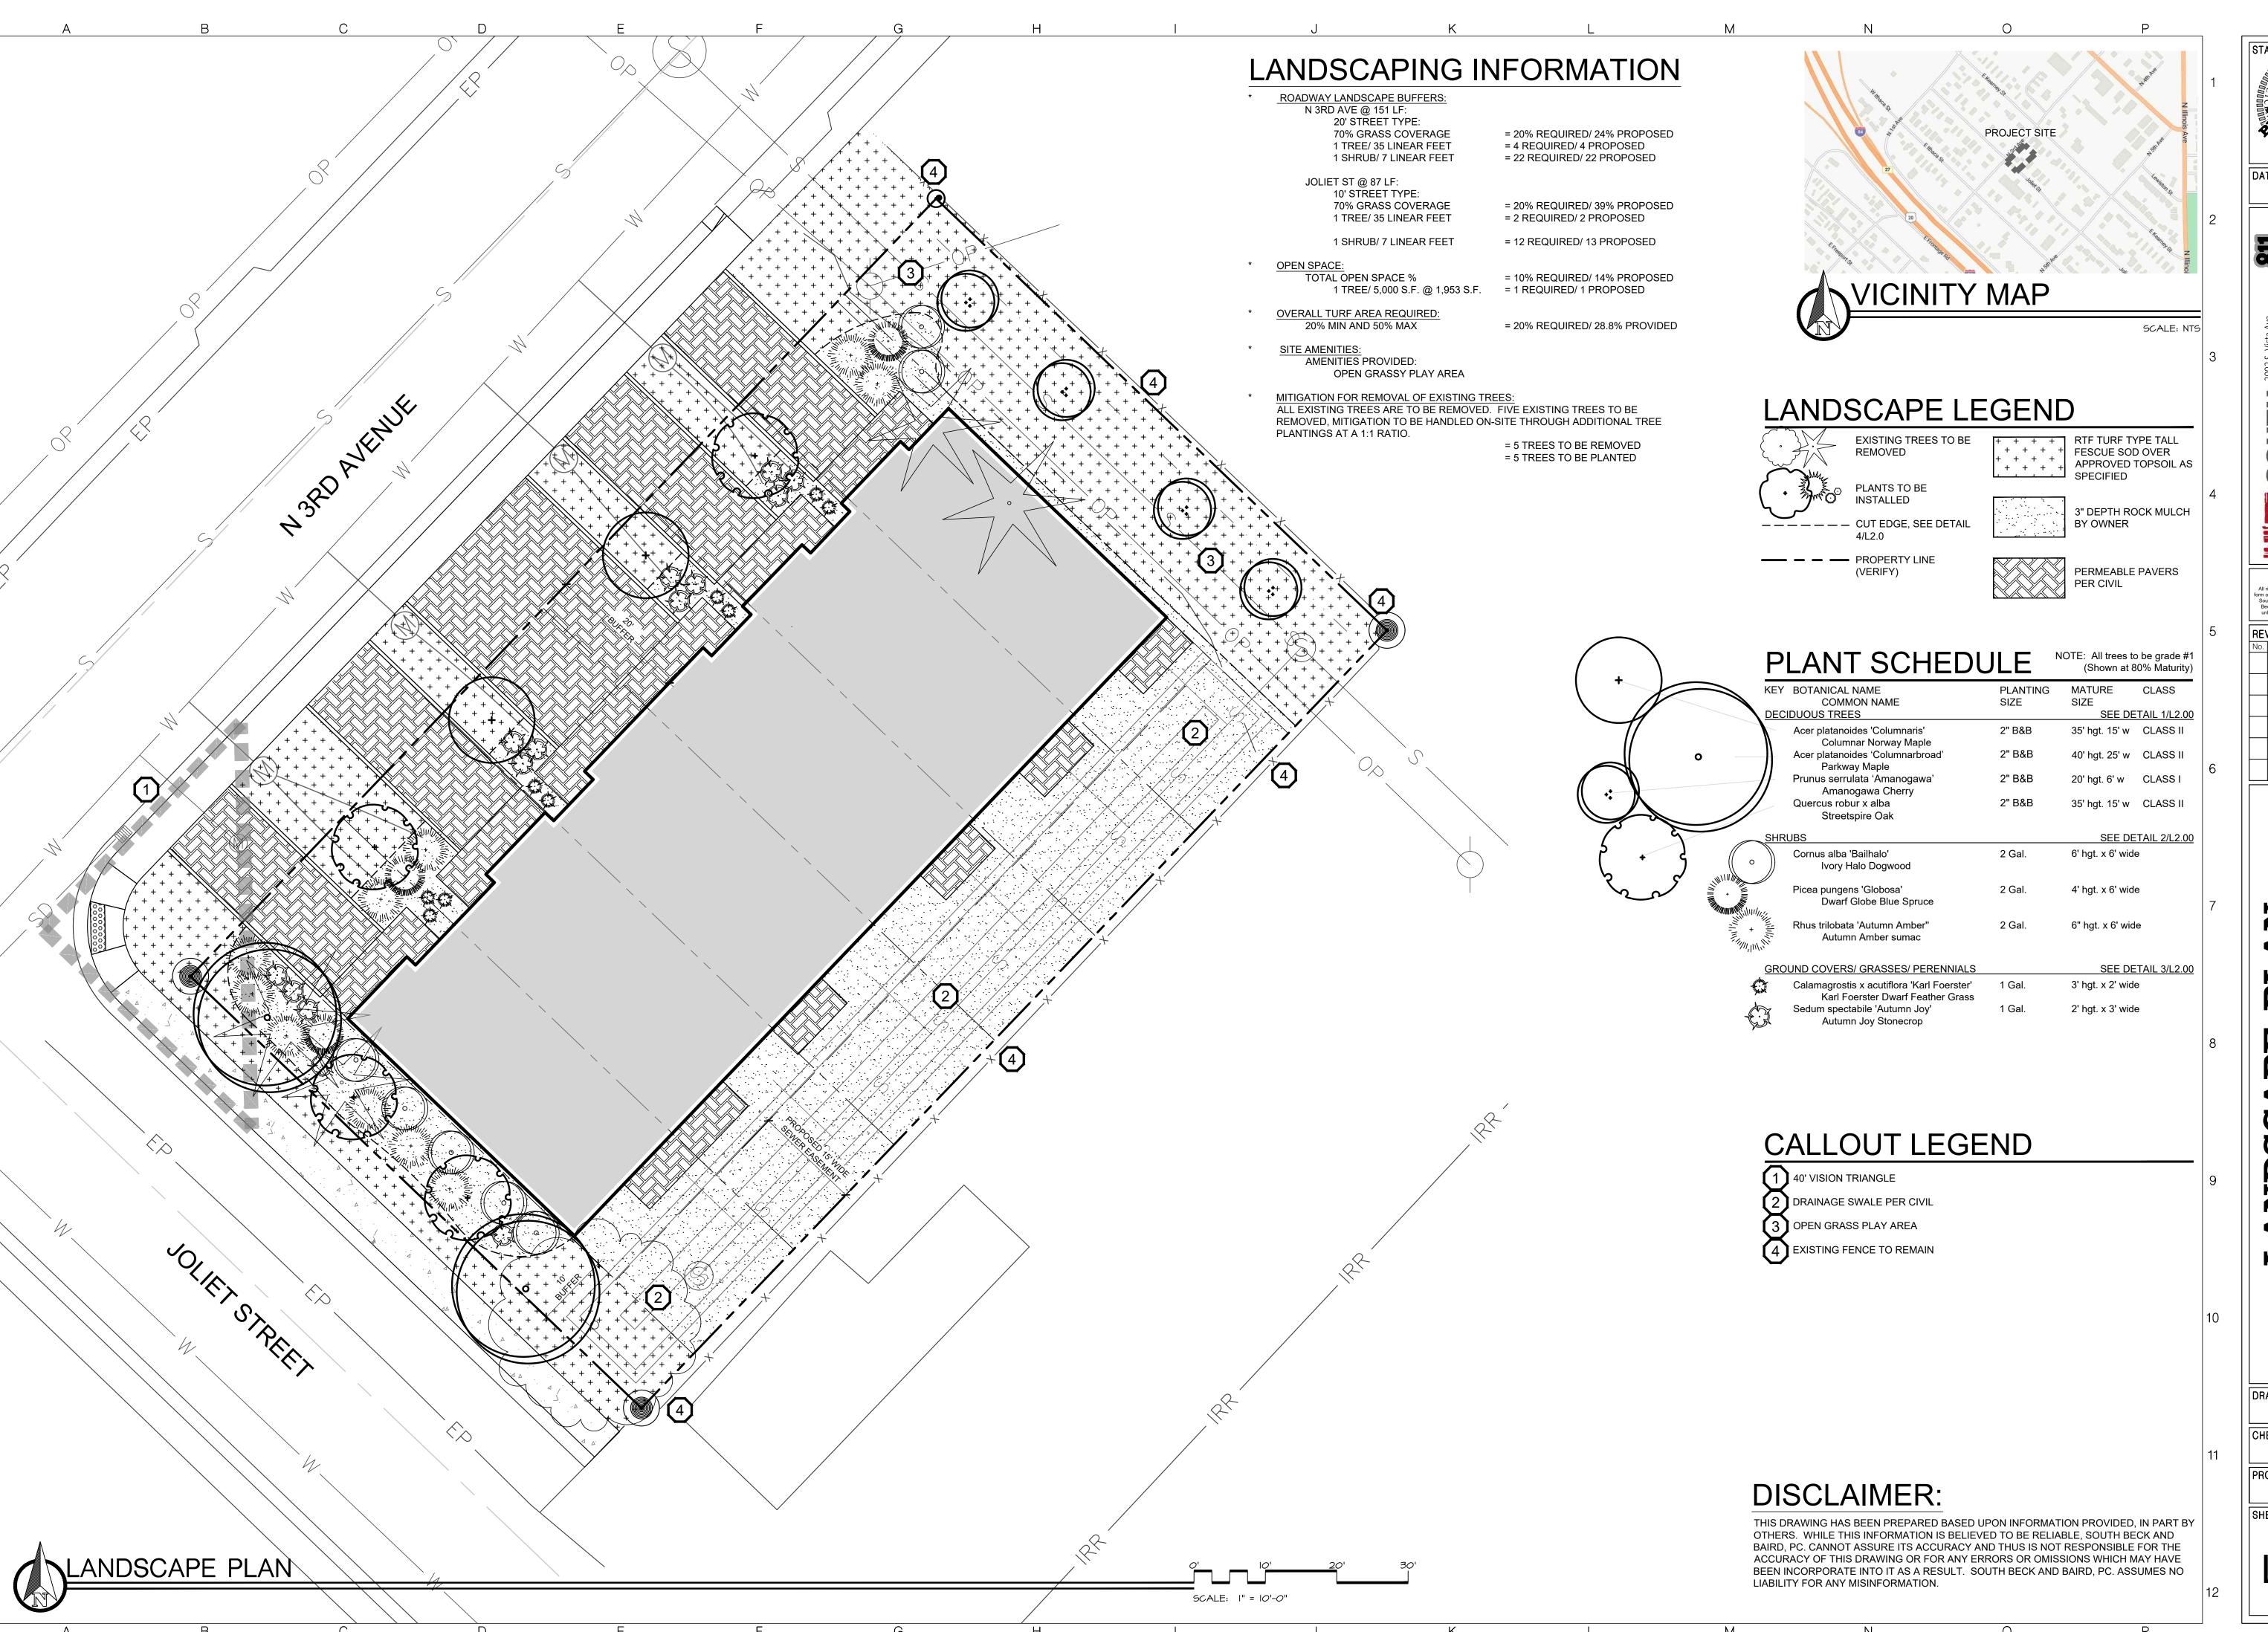

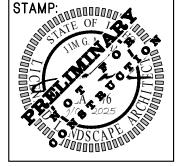

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DRAWN BY: CHECKED BY:


PROJECT NUMBER

25-288

WHEN PRESENT: BUD -POINT (A MINOR CROOK ROOT FLARE/COLLAR (SWELLING AT SOIL IN THE TRUNK JUST LINE WHERE STEM TISSUE TRANSITIONS ABOVE THE SOIL LINE) INTO ROOT TISSUE) TO BE AT SOIL LINE. TO BE APPROXIMATELY 1 1/2" ABOVE THE SOIL LINE PREVAILING WIND DIRECTION ROOT PROBE SOIL LINE - REMOVE DEAD/DAMAGED BRANCHES AND PRUNE TO INTERNATIONAL SOCIETY OF ARBORICULTURE STANDARDS; IMPROPERLY PRUNED TREES (AS DETERMINED BY THE LANDSCAPE ARCHITECT) SHALL BE REMOVED AND REPLACED. DO NOT REMOVE MAIN HIGHEST ROOT SHALL BI LEADER!! 2" MAXIMUM BELOW SOIL LINE. UTILIZE SOIL/ROOT RUBBER CINCH TIE PROBE AROUND TRUNK (APPROX 1"-2" AWAY _ 2"x 2" WOOD STAKE (LENGTH AS FROM TRUNK) TO REQUIRED)-DO NOT PENETRATE ROOTBALL LOCATE HIGHEST SEE NOTE 1. SET STAKES PARALLEL TO ROOTS. PREVAILING WIND. - REMOVE TREE WRAP TRUNK PROTECTION, AFTER INSTALLATION CONSTRUCT 2" EARTH BERM AT EDGE OF ROOTBALL, FILL TREE RING W/ MULCH, AS SPECIFIED. 3" THICK MULCH LAYER, KEEP MULCH 3" AWAY FROM TRUNK. REMOVE BURLAP, TWINE, AND WIRE BASKET FROM FINISH GRADE TOP ⅔ OF ROOTBALL, COMMERCIAL SLOW RELEASE FERTILIZER REMOVE ALL NAILS, TIES, of TABLETS AND PLASTIC FROM ROOTBALL. IF SIDES OF HOLE ROUGH & UNEVEN SYNTHETIC BURLAP IS UTILIZED TO WRAP THE BACKFILL WITH APPROVED TOPSOIL AND ROOTBALL, IT SHALL BE SOIL AMENDMENTS AS SPECIFIED. COMPLETELY REMOVED BACKFILL IN 6" LIFTS, WATER EACH LAYER, ONLY BIODEGRADABLE TAMP LIGHTLY AS REQUIRED. BACKFILL WIDTH WIDTH WIDTH " WIDTH WIDTH BURLAP SHALL BE LEFT SOIL EVEN W/ TOP OF ROOTBALL, ON THE BOTTOM OF THE OF BALL OF BALL OF BALL OF BALL OF BALL DO NOT OVER COMPACT!! ROOTBALL 3' MIN. DIA. TREE RING SET ROOTBALL ON NATIVE, UNDISTURBED


- THE STAKING OF TREES IS TO BE THE CONTRACTORS OPTION; HOWEVER, THE CONTRACTOR IS RESPONSIBLE TO INSURE THAT ALL TREES ARE PLANTED STRAIGHT AND THAT THEY REMAIN STRAIGHT FOR LENGTH OF WARRANTY PERIOD OR 1 YEAR AFTER SUBSTANTIAL COMPLETION WHICHEVER IS GREATER. ALL STAKING SHALL BE REMOVED AT THE END OF THE
- IN THE EVENT OF A QUESTION OR LACK OF CLARITY ON THE DRAWINGS, THE CONTRACTOR IS TO NOTIFY THE LANDSCAPE ARCHITECT BEFORE PROCEEDING.
- LANDSCAPE CONTRACTOR IS TO NOTIFY THE LANDSCAPE ARCHITECT AND OWNER PRIOR TO INSTALLATION OF PLANT
- WRAP RUBBER CINCH TIES AROUND THE TREE TRUNKS AND STAKES USING EITHER THE STANDARD OR FIGURE EIGHT TYING METHOD. SECURE THE TIES TO THE STAKES WITH GALVANIZED NAILS TO PREVENT SLIPPAGE.
- WATER TREE TWICE WITHIN THE FIRST 24 HOURS. IN THE EVENT HARDPAN SOILS PREVENT TREE PLANTING AS DETAILED, NOTIFY THE LANDSCAPE ARCHITECT IMMEDIATELY. FOR TREES LOCATED WITHIN 5'-0" OF A CONCRETE CURB OR WALKWAY, PROVIDE TREE ROOT BARRIER (DEEPROOT #24-2 OR APPROVED EQUAL). LOCATE ROOT BARRIER AT BACK OF CURB AND EDGE OF SIDEWALK. EXTEND ROOT BARRIER TO 80% OF MATURE TREE CANOPY. ALL TREE INSTALLATIONS SHALL CONFORM TO ALL AGENCY APPROVAL REQUIREMENTS, CONTRACTOR SHALL VERIFY PRIOR TO ANY INSTALLATIONS.




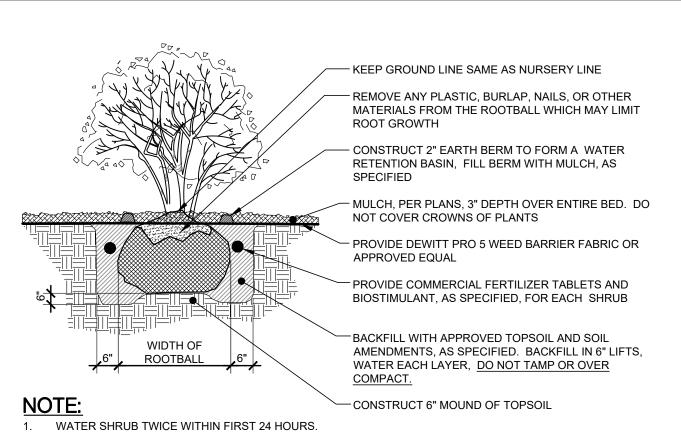


APPLY SPECIFIED PRE-EMERGENT PER MANUFACTURER'S RECOMMENDATIONS TO ALL GROUNDCOVER BEDS. SHRUB PLANTING

NOT TO SCALE

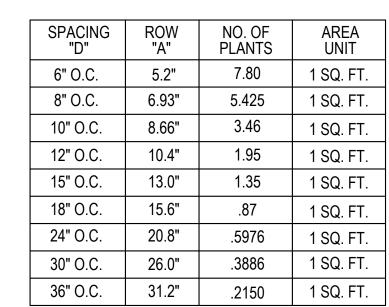


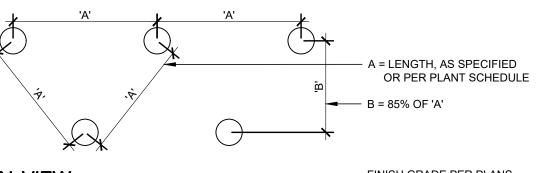

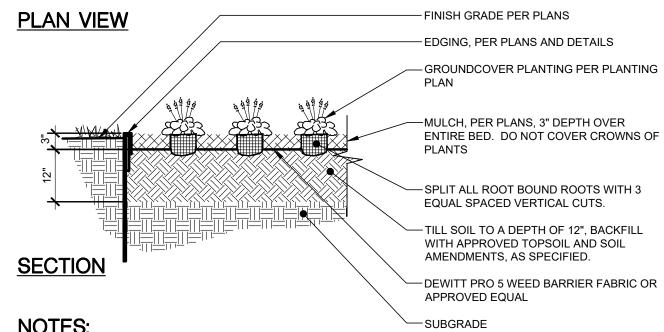

ALL GROUNDCOVER PLANTS TO BE PLANTED ON CENTER AND IN A TRIANGULAR PATTERN. APPLY SPECIFIED PRE-EMERGENT PER MANUFACTURER'S RECOMMENDATIONS TO ALL GROUNDCOVER



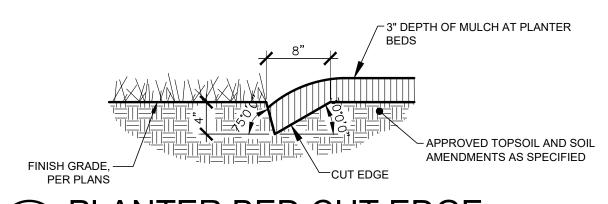



NOT TO SCALE

CHECKED BY:

25-288

09/05/25

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REVISIONS:

DRAWN BY:

SCM

PROJECT NUMBER

Preliminary Plat Narrative – DEAL Submittal Applicant: Burke Deal, Ideal Custom Homes Inc. Project Title: Townhouse Subdivision – Parcel R02125

Property Address: 2011 N. 3rd Avenue, Caldwell, ID 83605 Zoning Classification: R-2 Medium-Density Residential

Assessor's Parcel Number (APN): R02125

Secondary Access: Joliet Street

Development Program: DEAL (Development Enhanced Agreements for Livability)

Executive Summary

This proposal entails the subdivision of APN R02125 pursuant to the City of Caldwell's DEAL framework to facilitate construction of a six-unit townhouse development. The subject site is strategically positioned for low-impact infill and is consistent with adopted land use and zoning protocols outlined in the City's Comprehensive Plan. The development advances public infrastructure coordination, medium-density housing initiatives, and neighborhood integration consistent with R-2 overlay guidelines.

Subdivision Configuration and Residential Typology

- The preliminary plat subdivides the parcel into six fee-simple lots for vertical townhouse units
- Each dwelling will feature a single-car garage, driveway, and three-bedroom floorplan
- All primary entries and garages are oriented toward N. 3rd Avenue, ensuring consistent urban frontage and visual rhythm
- Setbacks, lot widths, and dimensional compliance align with the R-2 district's prescribed standards

Circulation and Public Frontage Enhancements

- Vehicular ingress/egress is consolidated along N. 3rd Avenue, minimizing access points and preserving traffic flow
- Pedestrian improvements include installation of sidewalks and curb infrastructure along Joliet Street
- Common landscape buffers (15' along N. 3rd Avenue; 10' along Joliet Street) will be implemented to soften urban edges and enhance walkability

Utility Infrastructure and Easement Coordination

- Municipal water and wastewater conveyance systems are located within N. 3rd Avenue, running continuously parallel to the parcel's northwest boundary
- Municipal irrigation infrastructure is available on the southeast rear property line, abutting Joliet Street and supporting xeriscaping and native plant palettes
- A 19-foot-wide utility easement at the parcel's northeast corner will be preserved for existing City sanitary infrastructure and overhead Idaho Power service. No vertical construction is proposed within easement boundaries

Compliance, Conformance, and Benefit Analysis

- This plat meets all statutory and administrative requirements for subdivision approval under the DEAL Program:
- Zoning Conformance: All proposed lots comply with R-2 dimensional standards, use regulations, and density allowances
- Infrastructure Optimization: Existing utility corridors are leveraged to minimize disturbance and installation cost
- Enhanced Livability: Landscape buffers, pedestrian routes, and integrated unit design promote a livable, walkable environment consistent with City vision
- Development Coordination: This project illustrates ideal alignment between private development and public resource allocation

Attachments and Supplemental Documentation

- Scaled Preliminary Plat Drawing
- Lot Configuration Table
- Utility and Easement Exhibit
- Landscape Plan Sheet
- DEAL Program Submittal Checklist

County Recorder of Canyon County, Idaho, and running thence in a North easterly direction along the Northwesterly boundary line of said Block 48 a distance of 176 feet; thence running in a Southeasterly direction on a line parallel with the Southwesterly boundary line of said Block 48 a distance of 87.5 feet; thence running Southwesterly on a line parallel with the foresaid Northwesterly boundary line a distance of 176 feet to a point in the Southwesterly boundary line of said Block 48; thence running Northwesterly along the Southwesterly boundary line of said Block 48 a distance of 87.5 feet to the point of beginning;


Less 25 Foot of Right of Way.




VICINITY MAP

RECORD OF SURVEY

A PORTION OF BLOCK 48 OF GOLDEN GATE ADDITION TO CALDWELL, YING IN THE NW 1/4 NE 1/4 OF SECTION 22 AND THE SW 1/4 SE 1/4 OF SECTION 15, TOWNSHIP 4 NORTH, RANGE 3 WEST, BOISE MERIDIAN, CANYON COUNTY, IDAHO

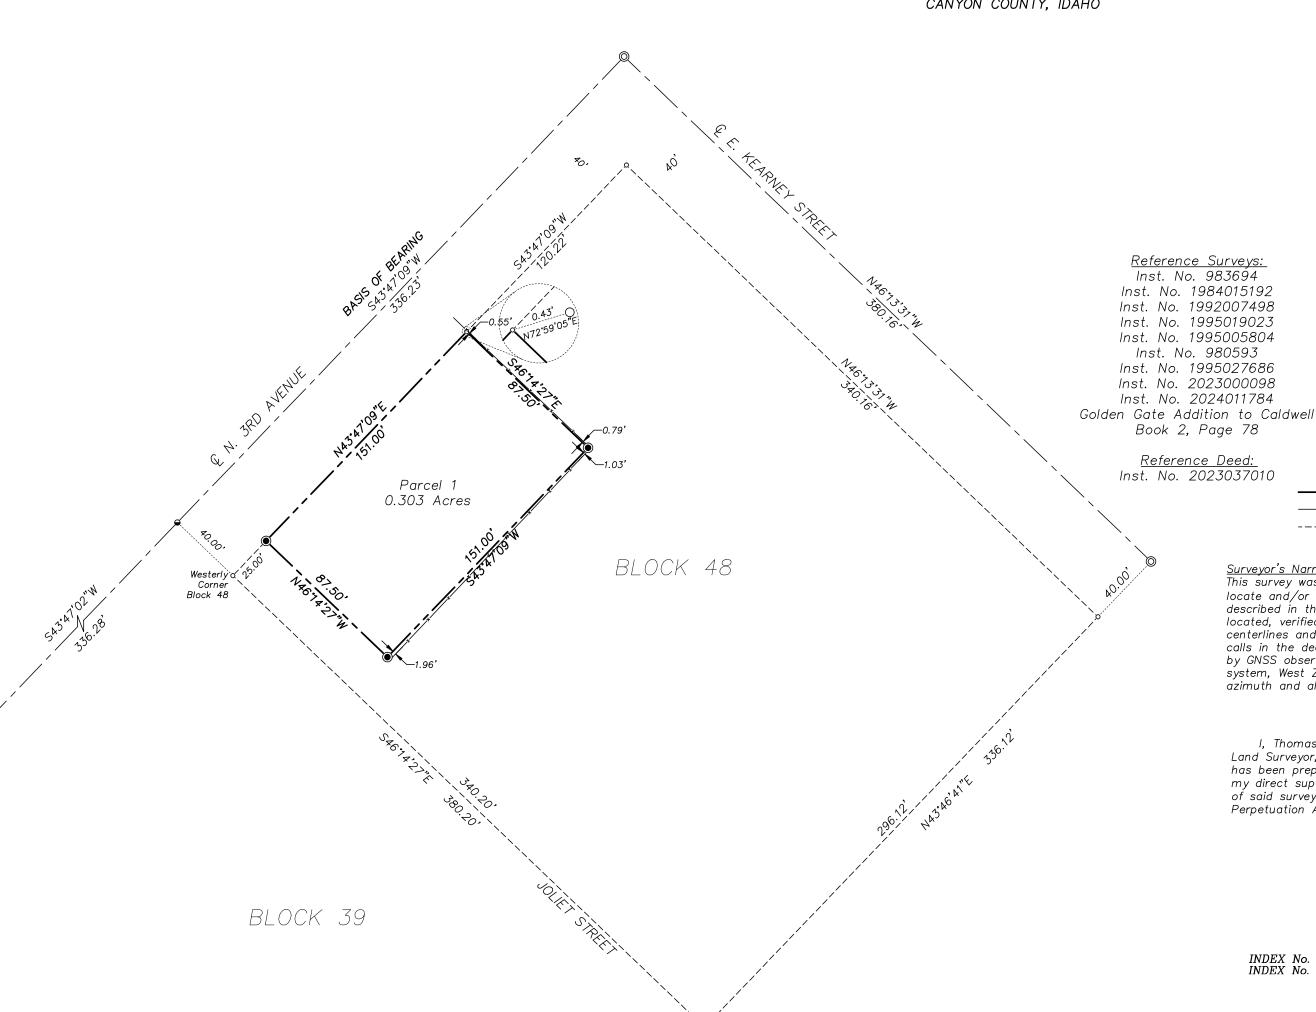

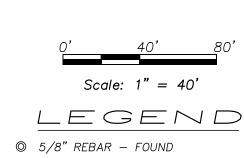


○ 1/2" REBAR - FOUND ■ MAGNAIL - FOUND CALCULATED POINT ----- PROPERTY BOUNDARY LINE ----- ROAD CENTERLINE ---- ORIGINAL BLOCK LINE

This survey was performed at the request of Ideal Custom Homes to locate and/or monument the property corners of the parcel that is described in the referenced deed. Centerline road monuments were located, verified and held as shown. Right of ways were offset from centerlines and property corners were established by holding controlling calls in the deed. The basis of bearing for this survey was established by GNSS observations, projected to the Idaho State Plane Coordinate system, West Zone, NAD83 datum. All bearings shown are on grid azimuth and all distances are ground at project elevation.

CERTIFICATION

I, Thomas J. Wellard, do hereby certify that I am a Professional Land Surveyor, licensed by the State of Idaho, and that this map has been prepared from an actual survey made on the ground under my direct supervision, that this map is an accurate representation of said survey, and that it is in conformity with the Corner Perpetuation Act, Idaho Code 55-1601 through 55-1612.

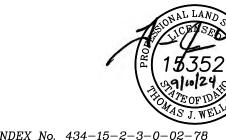


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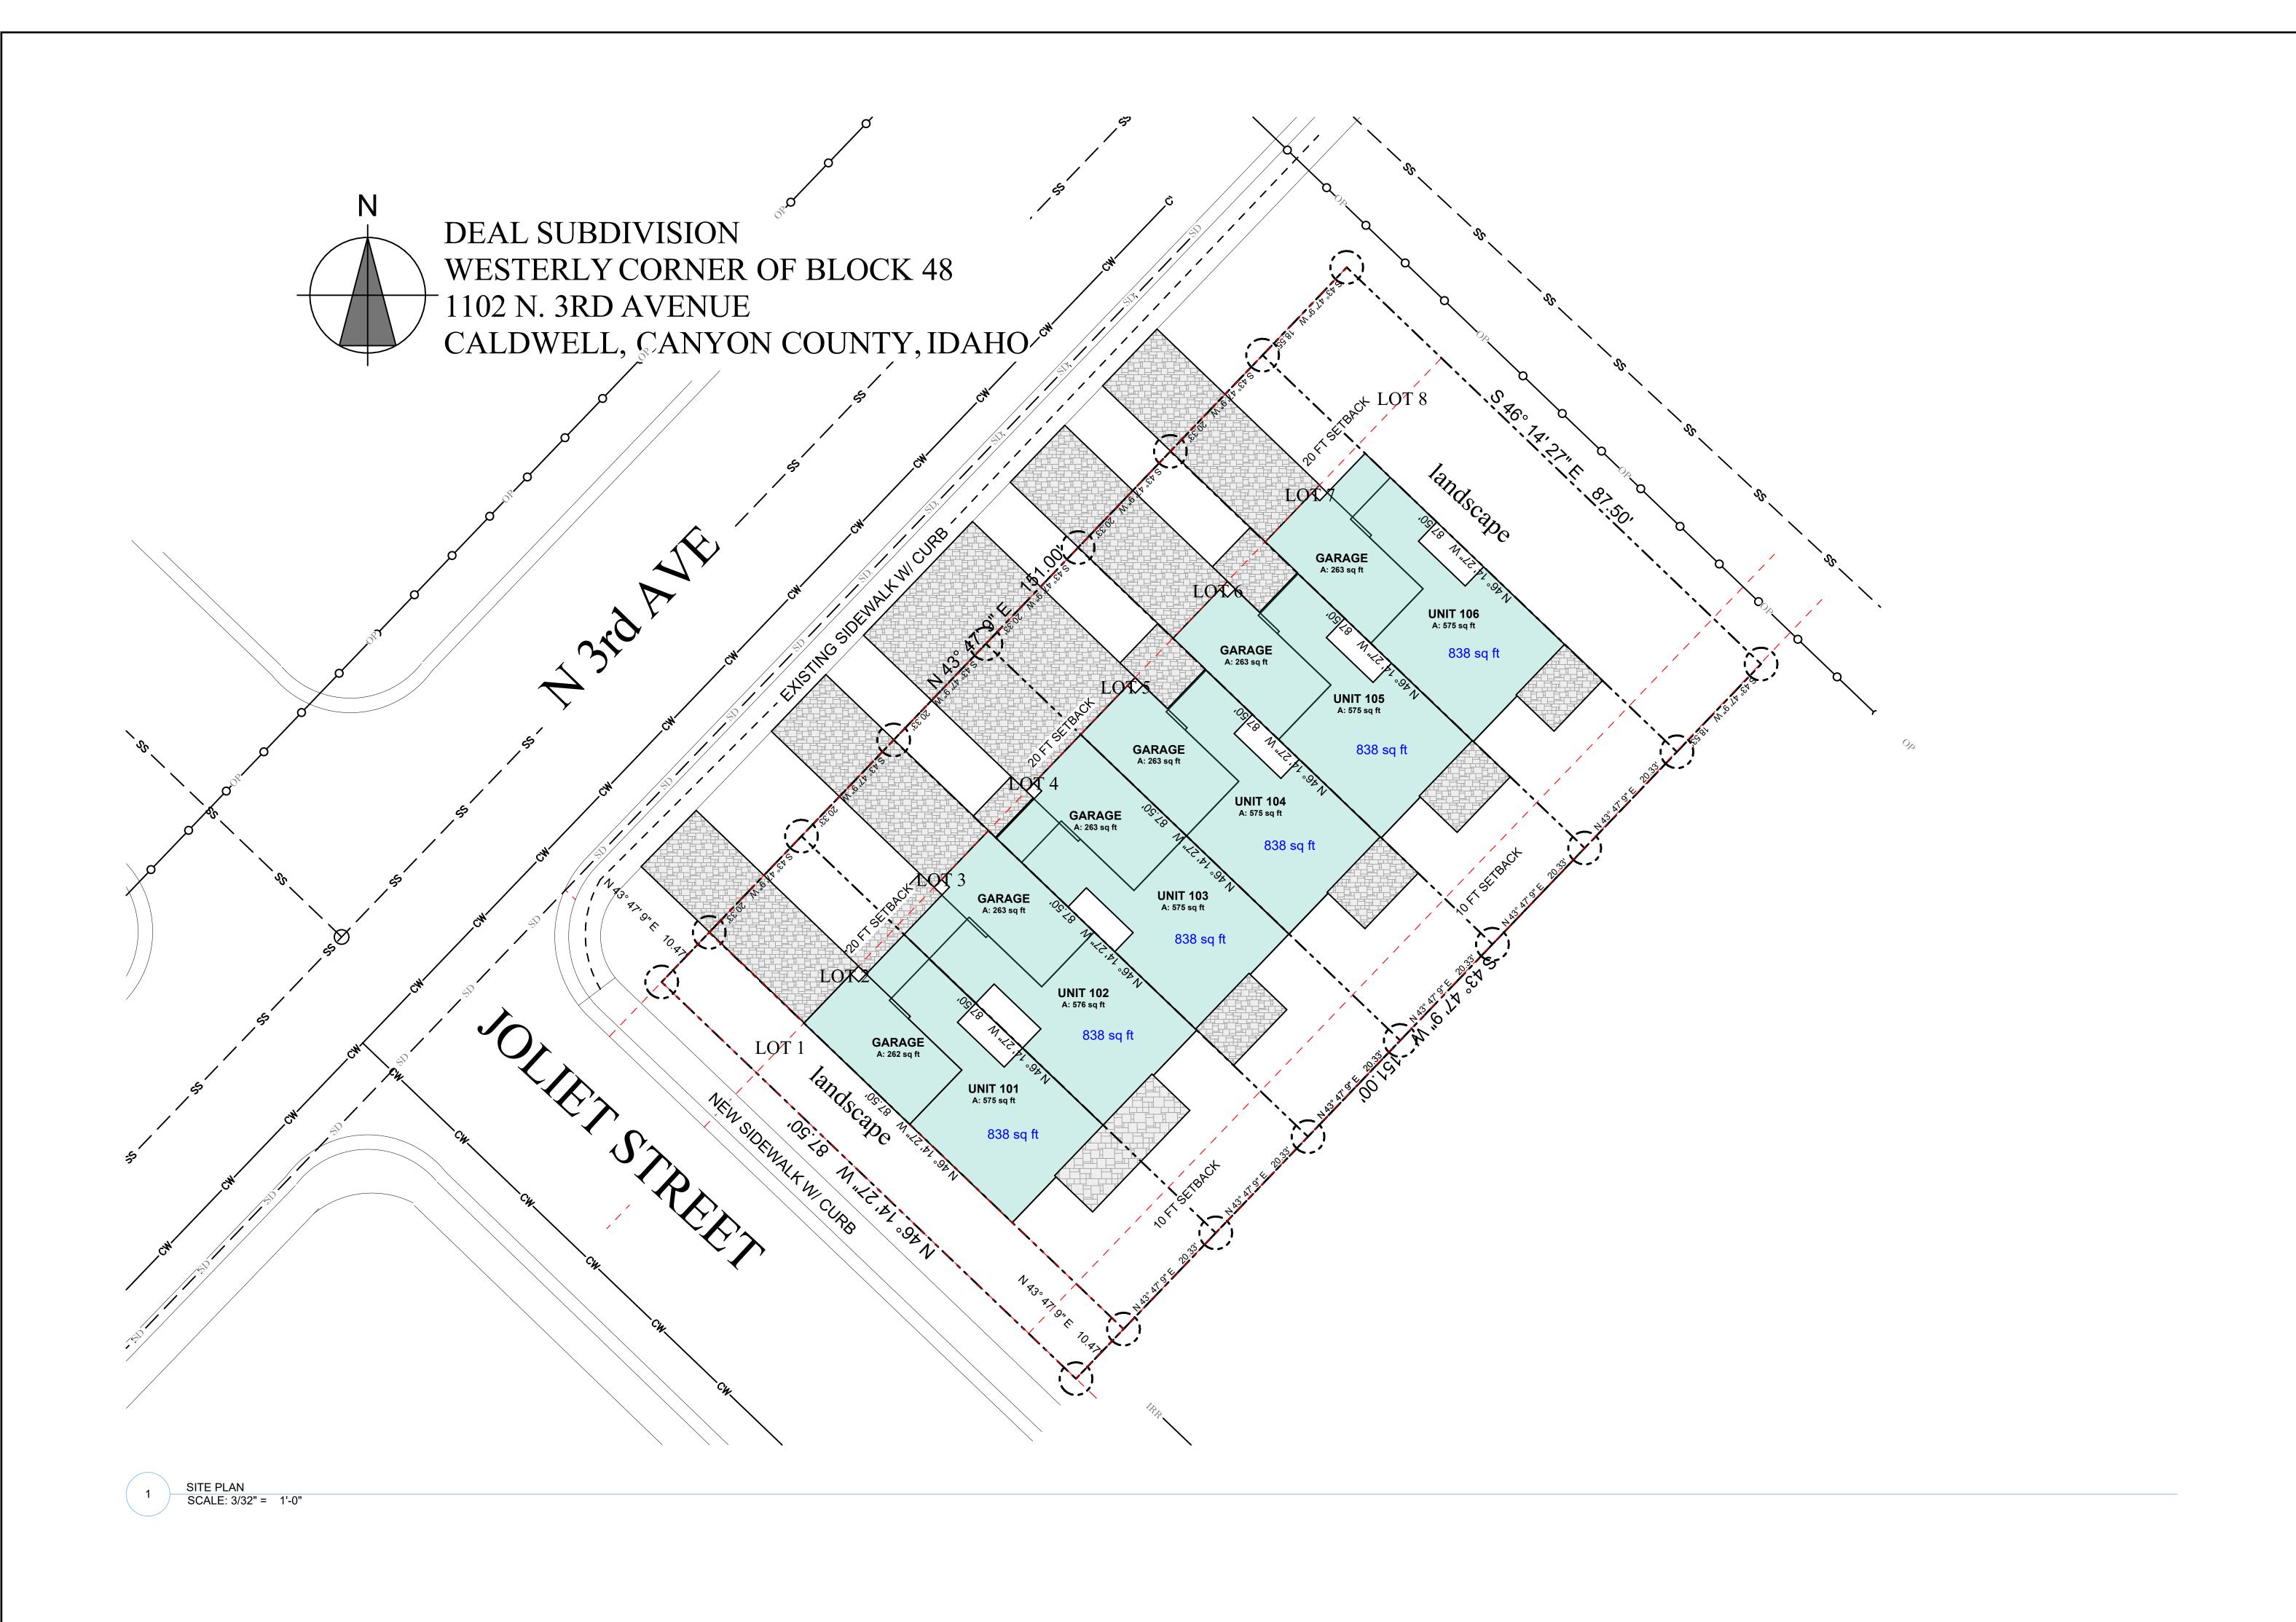
DO NOT SCALE DRAWINGS WSON DESIGN INC As Shown

PRELIMINARY PLAT COVER SHEET

PROFESSIONAL SEAL

A-1.1




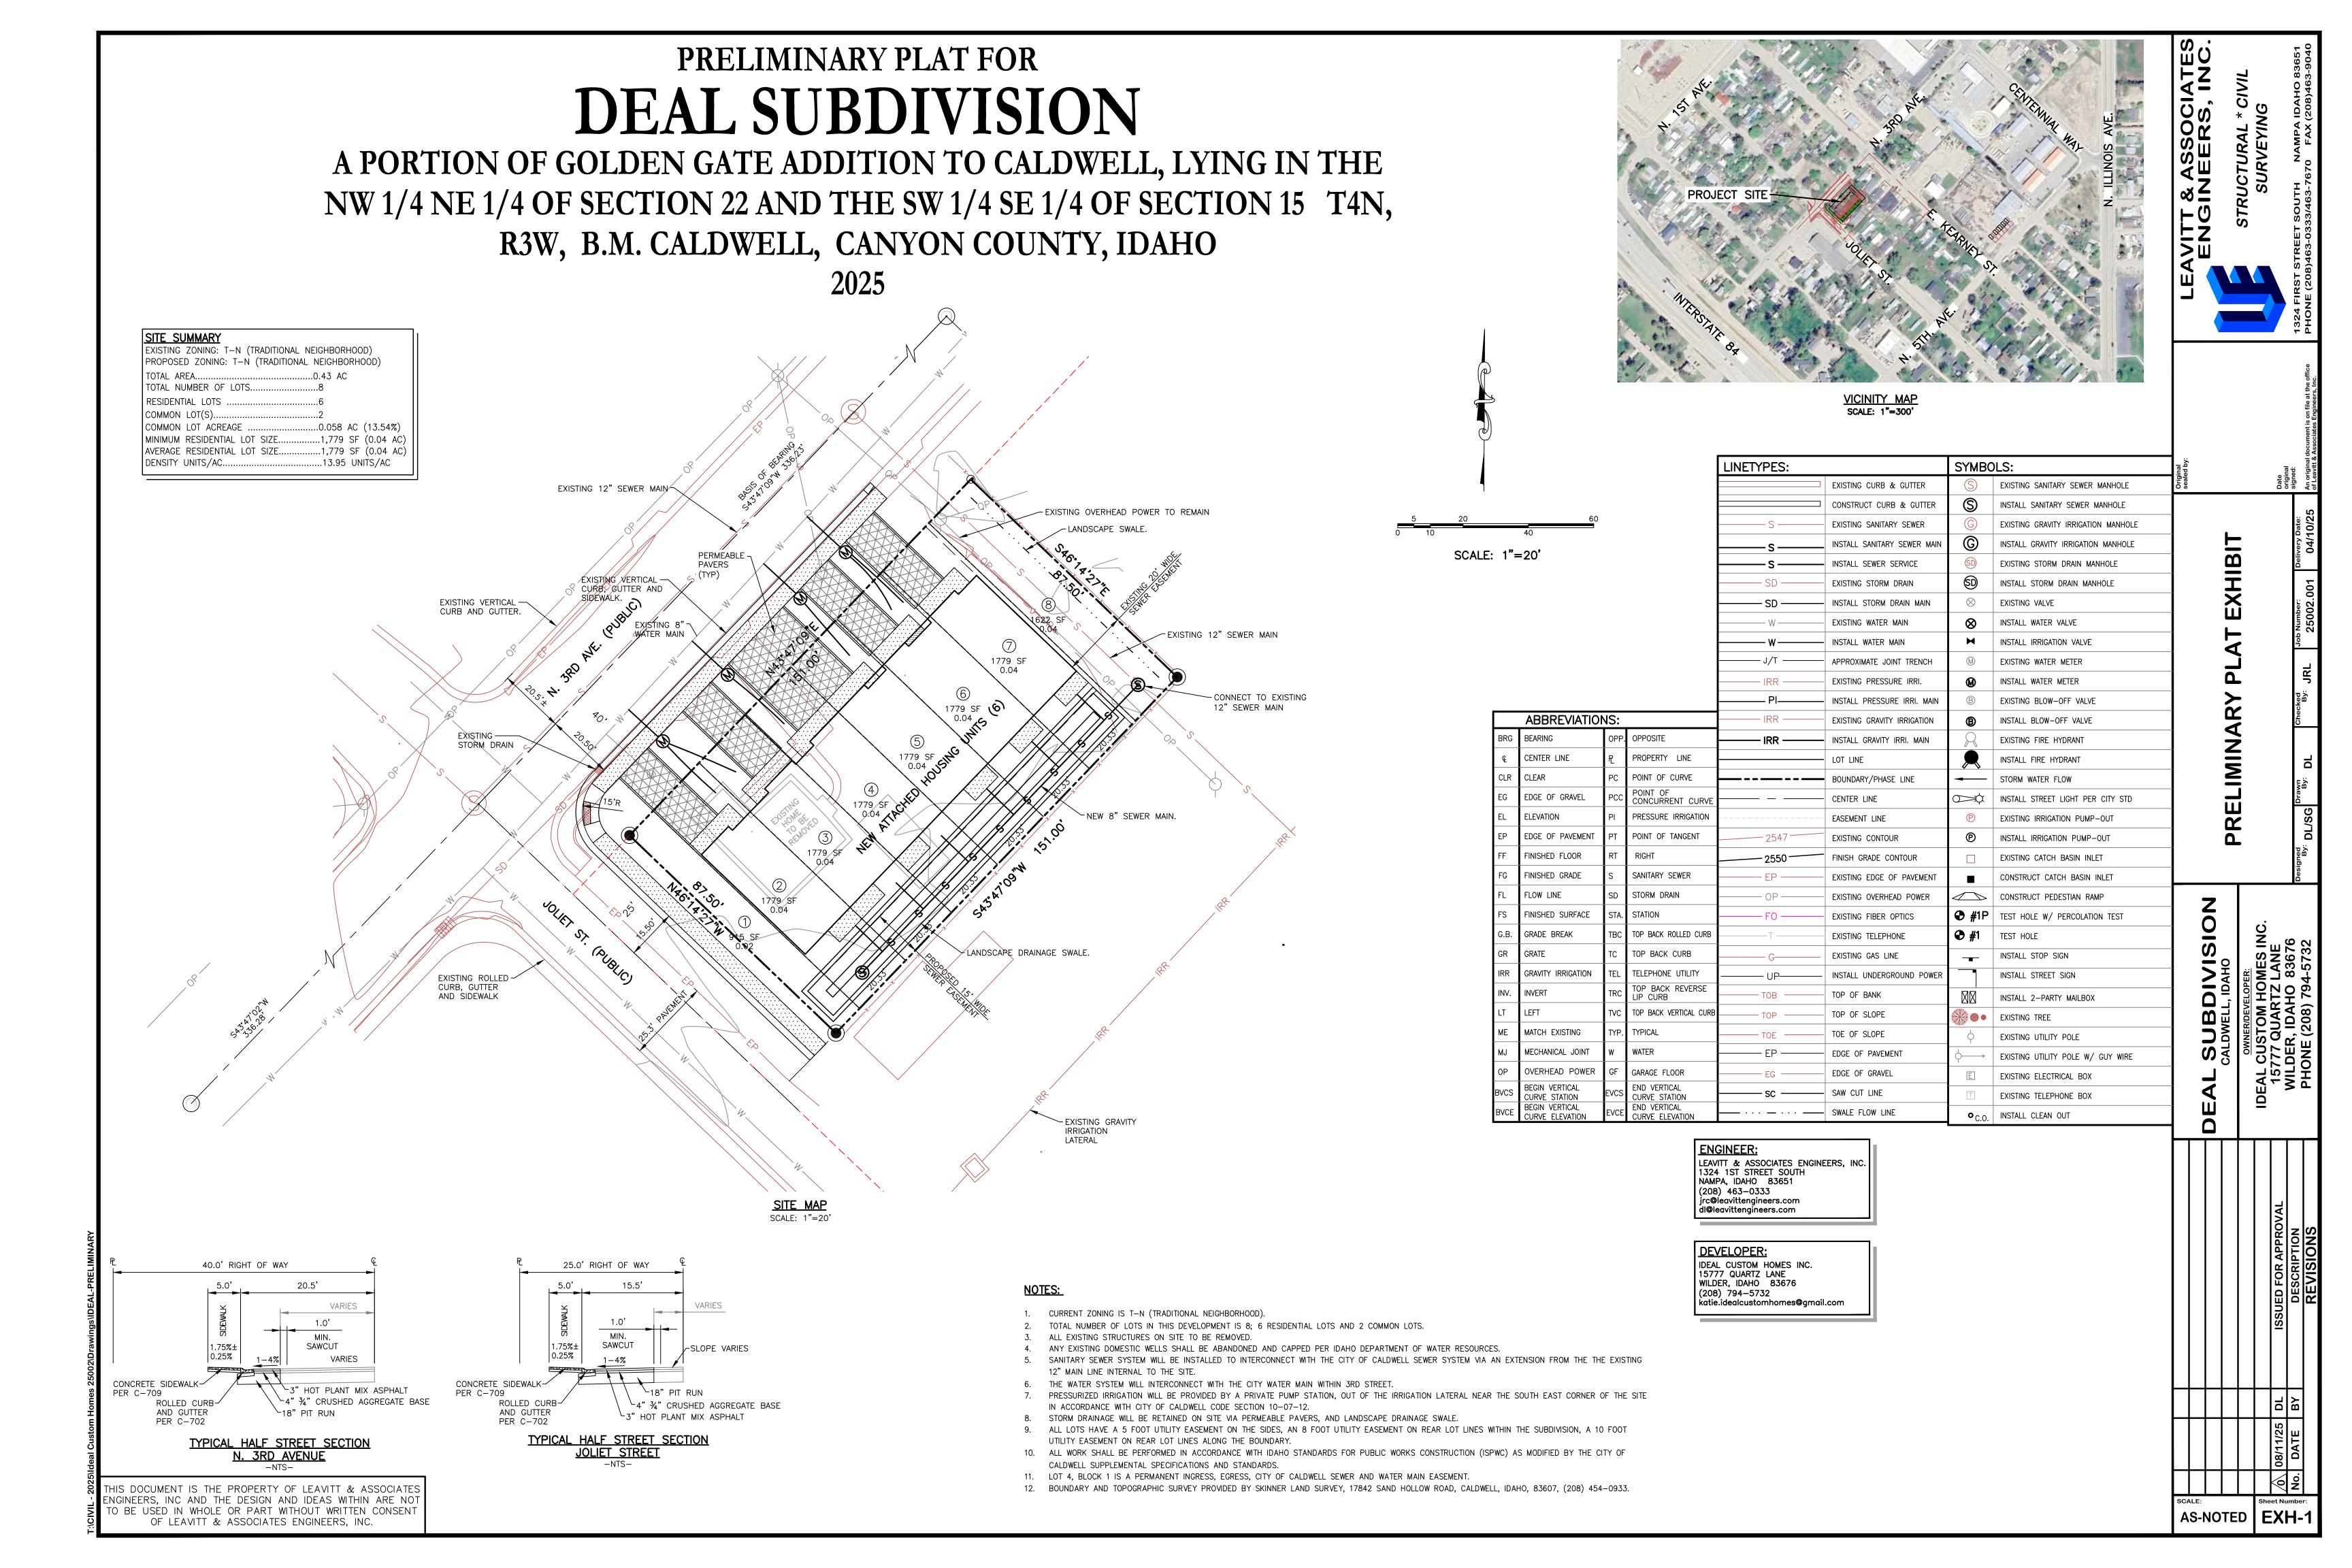



Phone 208-989-1422 MAIL: gary@lawson-desig



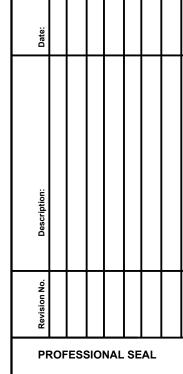

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Drawn By:	Date:	
LAWSON DESIGN INC.	Monday, September 8, 2025	
Scale:	JOB NUMBER:	
As Shown	#DIn	

A-1.3

Drawing Title:
ARCITECTURAL
SITE PLAN





2018 INTERNATIONAL ENERGY CONSERVATION COE IECC



THE PROPSED BUILDING HAS BEEN DESIGNED TO MEET OR EXCEED THE REQUIRMENTS OF THE INTERNATION ENERGY CONSERVATION CODE

INSULATION AND FENESTRATION BY COMPONENT

CLIMATE	WINDOW	CEILING	WOOD WALL	FLOOR	SLAB	CRAWL SPAC
ZONE	U-FACTOR	R-VALUE	R-VALUE	R-VALUE	R-VALUE	R-VALUE
В	.31	38	21	30	10	

DESIGN CRITERIA: CALDWELL CITY

DESIGN LOADS

Seismic Design Category: B

Wind Speed: 115 mph

Roof Snow Load: 25 psf
Ground Snow Load: 20 psf

Frost Depth: 24 inches

Collateral Load: minimum 5 psf

CODES: IRC 2018, IECC 2018

2018 International Residential Code (IRC) – Parts I, II, III, IV, and IX

2018 International Building Code (IBC)

2018 International Energy Conservation Code (IECC), with state amendments


Plus: Mechanical, Fuel Gas, Fire, Existing Buildings, Plumbing, Property Maintenance, and Electrical Codes (NEC)

Gentennial Way	PumpTech O A Control of the control	La Centennial May	
	E Roalings of	Caldwell Street Department Ivan's Street Dreams Auto Sales	Centenness Articles
aldwell Automotive	Lindsay & Co	E teamer or	Wilson's RV Repair- Caldwell PROJECT LOCATION RESTOREX of Caldwell PROJECT LOCATION
C C C C C C C C C C C C C C C C C C C	E SE LINE	Templo De Bethel Pentecostal	The Free Live of the State of t
	Estons, Ashir Library Lifens Park Minty Vinty	Halinital St.	Aotor Inn Davis Success

	SHEET INDEX		
ID	Name		
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C-1	OVERAL LAYOUT		
C-2	NOTES		
CSC3	DEMOLITION		
CSC4	GRADING AND STREET WIDENING PLAN		
C-5	SEWER DETAIL		
C-6	GRADING AND DRAINAGE DETAILS		
L1.00	LANDSCAPE PLAN		
L2.00	LANDSCAPE NOTES & DETAILS		
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A-202	ELEVATIONS		
M1	ELECT PLANS		

Phone 208-989-1422
E-MAIL: gary@lawson-design.com

DEAL SUBDIVISION 3RD AVER CALDWELL DAH

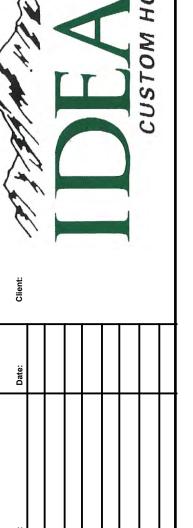

DO NOT SCALE DRAWINGS

Drawn By: Date:
WSON DESIGN INC. Monday, September 8, 2025

T-1

Drawing Title: